

Artesia

*Project Narrative / Development Review Board
589-PA-2016*

Location:
7171 N. Scottsdale Road



Prepared for:
Meritage Homes

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Page 1


16-DR-2017
4/3/2017

II. Context

The Property is located north of Downtown and just north of the Southern Scottsdale Character Area. The Property, bounded by the McCormick Ranch Golf Course (O-S) to the east, Traviata Condominiums (R-5) and Scottsdale Seville shopping center (C-2) to the south, Scottsdale Plaza Resort (SUP-R) to the west and the Scottsdale Office Center (C-2) to the north. The City-owned McCormick-Stillman Railroad Park is located to the south of Indian Bend Road.

III. Design & Development Plan Summary

The Artesia PA-1 development provides a luxury residential living experience with numerous onsite amenities and a resort-lifestyle that integrates with the existing urban fabric and collection of uses (resort, recreation, employment, retail, support services) in the nearby vicinity further contributing towards the variety of housing options available to the residents of Scottsdale. PA-1 is the center phase of the site as depicted below.

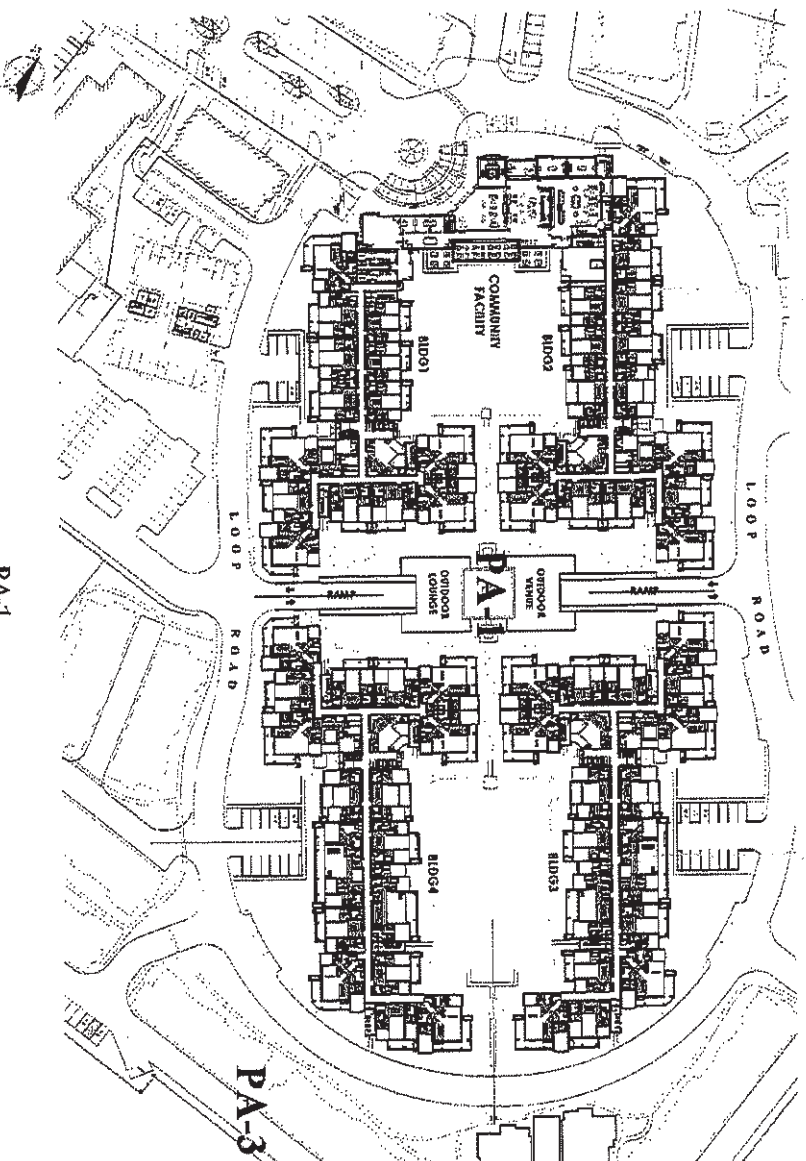

PA-1
SITE DEVELOPMENT PLAN

Residential Buildings

The Artesia mid-rise development consists of 4 buildings grouped around enhanced amenities and open space areas. Buildings will be 4 stories, 50' in height with 1 subterranean parking level and consist of 242 units (234 flats and 8 townhomes). The main visitor entry is thru the community facility frontage drop-off while owners enter into 1 of 2 subterranean garages along the loop road that access 1-2 designated parking spaces per unit and elevators to each floor level and unit. Additionally, guests will park in designated parking bays that front each building edging the loop road.

Within the cluster of buildings, resident plans range from 1,250 to 3,750 square feet. The plan variations allow for 2br/2ba units up to 3br/3.5ba units that have den/libraries and home theaters. By design, the main focus in the units are the entry zones, great room functions and exterior verandas that are so appealing and usable. In example, entry areas are intended as the 'meet and greet' private space prior to fully entering into each residence, while great room areas of kitchen, dining and living room are designed to be open, large and exposed to the exterior verandas. The glazing facing the verandas contain larger than average sliding doors that when open activate the indoor / outdoor space of enhanced vertical living within a mid-rise development.

The covered verandas are very distinctive as they are the private open space for residents, but moreover, they also serve as an extension of usable square feet above and beyond unit square feet. Also by design, a great majority of bedroom wings, whether master or secondary, have veranda exposure in front of their rooms and subsequently maximize the indoor / outdoor uses across each unit exterior.

As residents, one has access from their own building to the community facility, two separate pool areas, a central spine leading to significant open space between all four buildings, along with a path of travel that allows for a perimeter walkable community. In addition, there are walks that link to the retail frontage of the project and other surrounding retail zones.

The architectural character, massing and texture embody Contemporary Southwest style:

Design Details

1. Verandas - outdoor spaces with columns disengaged from railing provide contemporary detail
2. Eaves - corbels / rafter tails provide transitional character and massing
3. Railings - both glass and wire mesh railing provide contemporary detailing
4. Roof - both flat roof and sloping tile roof provide transitional character and massing
5. Stucco - combined smooth / sand finishes provide transitional texture variation

Color and Material

6. Building - light cream stucco with smooth and sand finishes
7. Stone - veneer in light coral and medium tone adoquein
8. Bronze trim - railings, corbels, rafter tails, veranda edges
9. Beige trim - door and window trim
10. Roof tile - flat tile grey tone

Community Facility/Clubhouse

The community facility is the meaningful common area/clubhouse amenity for the residences located on the north end of PA-1. The building will be two levels with a roof top deck. The building entry facade serves as the backdrop to the semi-circle drop off under the porte-cochere. Once inside the entry doors, the two-story volume opens up for viewing of the lobby lounge / expansive fireplace wall, and the amazing view toward the multiple pools thru opened multi-sliding doors.

Beyond the lobby, multiple functions at the ground level include the concierge desk service, the sales gallery for the mid-rise residential units, the automated parcel locker room for mail and parcel deliveries, a bistro / bar lounge with wine lockers, the over-sized lounge gathering area containing seating, multi-media walls, demonstration kitchen, billiards, outdoor patio verandas, along with a service / delivery / storage access area for catering events. Additionally, there is a feature elevator and grand stairway that leads vertically to the second floor and rooftop amenities.

At the second level, multiple activity areas include a group theater for gathering and viewing special events, fitness center with yoga, spinning, exercise equipment and an outdoor relaxation veranda. On the opposite side of the building, there is an outdoor veranda overlooking the pool area, and a gallery leading to the business center setup with conference room for owner use, and the HOA offices at the end of the hall. Please note that moving to and from spaces on the second level, one will experience the overlook down into the lobby with views out to the pool area, and oppositely out to the front entry and water feature.

At the top level, one accesses the roof amenity by the grand staircase or elevator, and is exposed to a large ramada with bar / seating and catering options, along with individual section areas for BBQ and gathering farm tables, and lounge seating in multiple zones with fire and water features. The rooftop will provide that special retreat for distant viewing, overlooks to the pool and engaged space for gathering large groups for entertaining events.

The rear of the community facility faces the outdoor pool zone with four individual smaller pools serving different functions, along with individual surrounding cabanas, lounge chairs, along with central green open space adjacent to two covered verandas for reserved use.

Additionally, there is a kid zone that is tucked into the ground level of Building 2 and faces the rear exterior of the Community Facility. This zone is one of getaway for kids adjacent to the pool and Community Facility.

Landscape/Outdoor Spaces

Artesia's design concept from a site improvement perspective is "resort residential." A series of well linked "outdoor rooms" connect the resident to a variety of active and passive recreational spaces for the enjoyment of residents and guests. These spaces include pools, water features, fire features, solid roof shade structures, outdoor barbecues and outdoor kitchens. The planting design will complement the architecture, is more sun tolerant on the perimeter loop road and more shade tolerant in the internal courtyards due to the solar orientation of the 4-story structures. The importance of pedestrian linkage to connect this parcel to adjacent retail, restaurant and recreational amenities is well recognized and will be a critical component of the project's success. Landscaping is an important part of the Artesia resort-like environment and has been designed in a manner that enhances the pedestrian realm and emphasizes shaded walkways and shaded amenity areas in response to the desert environment.

IV. Development Review Board Criteria (Sec. 1.904)

A. In considering any application for development, the Development Review Board shall be guided by the following criteria:

- 1. The Board shall examine the design and theme of the application for consistency with the design and character components of the applicable guidelines, development standards, Design Standards and Policies Manual, master plans, character plan and General Plan.*

Response: Artesia PA-1 will comply with the applicable guidelines, development standards, Design Standards & Policies Manual, General Plan and Zoning Ordinance. While the zoning narrative submitted, and approved under separate application (2-ZN-2005#2, March 2015), outlined in more detail the broader context of the General Plan, below is a summary of how this proposal complies. The Property is described as being part of the "Resort Corridor" on the Character Type Map in the General Plan. The General Plan specifically identifies the Resort Corridor as consisting of concentrations of a variety of high-amenity residential, specialty retail, tourist accommodations, quality office and recreational uses. The proposed DRB submittal is

consistent with the specified uses within the Resort Corridor. The Property is not located within a specific Character Area of the General Plan, but is within close proximity to both the Southern Scottsdale Character Area and Downtown Plan.

The General Plan highlights the City's desire to maintain and expand the diversity of interconnected land uses and pedestrian synergy. Artesia fulfills this goal by bringing additional residential development to the Resort Corridor, further anchoring its presence and strengthening the economic stability of Scottsdale and helping to maintain a balance of land uses and promoting the "live-play-work" philosophy highlighted in the General Plan. The proposed development accomplishes a range of goals and policies including the redevelopment of a property, integrating high quality, vibrant architecture and site planning to the area, and creating pedestrian synergy that will complement the surrounding range of uses including commercial, recreation and resort.

2. The architectural character, landscaping and site design of the proposed development shall:

a. Promote a desirable relationship of structures to one another, to open spaces and topography, both on the site and in the surrounding neighborhood;

Response: The overall project architectural character is respectful of the surrounding built environment with heights and massing consistent with the zoning approved plans.

The site is relatively flat with existing underground parking. The common open space areas and landscape character of the proposed development includes a wide variety of plants that will provide year-round color, shade, and texture for the site. The proposed plant palette incorporates hardy plants known to thrive in the intense heat and sun of the desert climate. The planting design includes dense planting patterns and shade trees in areas with the most human interaction such as entries, amenity areas and pedestrian areas.

b. Avoid excessive variety and monotonous repetition;

Response: In addition to the comments above, a critical design quality that was considered in the building design was the importance of human scale. Human scale provides for both a higher quality pedestrian environment, which is created with a variety of small-scale buildings elements rather than a single large unarticulated building, and a sense of "home" for the residents. Inherently this type of design lends itself to visually interesting architecture vs. monotonous repetition or static building forms.

c. Recognize the unique climatic and other environmental factors of this region to respond to the Sonoran Desert environment, as specified in the Sensitive Design Principles;

Response: Please see the Scottsdale Sensitive Design Principle section below.

d. Conform to the recommendations and guidelines in the Environmentally Sensitive Lands (ESL) Ordinance, in the ESL Overlay District; and

Response: Not applicable.

e. Incorporate unique or characteristic architectural features, including building height, size, shape, color, texture, setback or architectural details, in the Historic Property Overlay District.

Response: Not applicable.

3. Ingress, egress, internal traffic circulation, off-street parking facilities, loading and service areas and pedestrian ways shall be so designed as to promote safety and convenience.

Response: With predominately underground parking, the development has removed the pedestrian obstacle of the parking lot from the streetscape and reinforced the idea of other alternative means of circulation. The ground level will also be activated with an open plaza-like feel. All buildings have 3 points of access to interior and exterior open spaces. There are also select units with direct access from the private verandas to the common open space areas. The common area will include quality hardscape surfaces, pedestrian furniture/seating, and shaded areas to enhance the pedestrian experience. The pedestrian connections around and through the site reflect a healthy urban environment and reinforce the desire to engage with the community through close proximity to a range of uses.

4. If provided, mechanical equipment, appurtenances and utilities, and their associated screening shall be integral to the building design.

Response: Mechanical equipment, both rooftop and ground plane will be screened by the building and/or walls and vegetation.

5. Within the Downtown Area, the building and site design shall: Not applicable.

6. The location of artwork provided in accordance with the Cultural Improvement Program or Public Art Program shall address the following criteria:

- a. *Accessibility to the public;*
- b. *Location near pedestrian circulation routes consistent with the existing or future development or natural features;*
- c. *Location near the primary pedestrian or vehicular entrance of a development;*
- d. *Location in conformance with the Design Standards and Policies Manual for locations affection existing utilities, public utility easements, and vehicular sight distance requirements; and*
- e. *Location in conformance and to standards for public safety.*

Response: Public Art, or the relocation of Public Art, is not part of this application but the applicant acknowledges the requirements for future applications.

B. The burden is on the applicant to address all applicable criteria in this section.

Response: Acknowledged above.



V. Scottsdale Sensitive Design Principles

The Character and Design Element of the General Plan states that “Development should respect and enhance the unique climate, topography, vegetation and historical context of Scottsdale’s Sonoran Desert environment, all of which are considered amenities that help sustain our community and its quality of life.” The City has established a set of design principles, known as the Scottsdale’s Sensitive Design Principles, to reinforce the quality of design in our community. The following Sensitive Design Principles are fundamental to the design and development of the Property.

1. The design character of any area should be enhanced and strengthened by new development.

Response: The building configuration, architectural character, site circulation, pedestrian connectivity, quality and amount of open scape, landscaping, and collection of amenities all factor into providing a design that enhances the unique southwestern character of Scottsdale. In keeping with the existing buildings on site, the new buildings will play off the established architectural theming, materials, and details for contextual appropriateness while providing a fresh new architectural style responding to today’s market demand and providing the types of units buyers are seeking in today’s market.

2. Development, through appropriate siting and orientation of buildings, should recognize and preserve established major vistas, as well as protect natural features.

Response: Although the setting of this site is suburban in character and does not have natural features such as washes and natural area open space, the developer has taken special consideration in maintaining providing meaningful open space, view corridors and recreational amenities for the residents tying back to the existing open space amenity (McCormick Ranch Golf Course) along the east of the Artesia development plan. The site has approximately 56% Open Space.

3. Development should be sensitive to existing topography and landscaping.

Response: The property is a redevelopment site. All landscaping will consist of low-water use desert appropriate landscaping materials. See Landscape Plan.

4. Development should protect the character of the Sonoran Desert by preserving and restoring natural habitats and ecological processes.

Response: The proposed development will preserve and restore natural habitats and ecological processes through the inclusion of additional desert appropriate landscaping (as well as integration of native plants). Additional landscaping will contribute to the suburban habitat for wildlife and improved air quality. Also, desert appropriate plants will be able to withstand the variations of the local climate and as they mature they will become self-sustaining relative to water demand. See Landscape Plan.

5. *The design of the public realm, including streetscapes, parks, plazas and civic amenities, is an opportunity to provide identity to the community and to convey its design expectations.*

Response: The site falls within the Suburban Streetscape per the Streetscape Map in the General Plan. The proposed development does not have a significant portion that touches Scottsdale Road but modifications and new entry elements are designed in a manner that is consistent with the Suburban Streetscape and Scottsdale Road plant palette. Pedestrian circulation along both the perimeter and internal to Artesia is an important feature of this project, as numerous retail, restaurant, resort/hotel, and recreational uses are within walking distances from this site.

6. *Developments should integrate alternative modes of transportation, including bicycles and bus access, within the pedestrian network that encourage social contact and interaction within the community.*

Response: The Artesia site is located along Scottsdale Road, a major arterial and just north of Indian Bend Road, a minor arterial. The Scottsdale Road corridor is flanked with commercial and resort development, which provide both a local and regional draw. This Property is nestled between commercial uses on the west, multifamily on the south and developed open space (golf) on the north and northwest and is naturally a very walkable location based on the surrounding context.

7. *Development should show consideration for the pedestrian by providing landscaping and shading elements as well as inviting access connections to adjacent developments.*

Response: The proposed development will incorporate design elements that respect human-scale, providing shade and shelter through building, site and landscape design.

8. Buildings should be designed with a logical hierarchy of masses.

Response: Central to the overall Artesia development plan, the proposed use of building massing for PA-1 is compatible to surrounding developments and is appropriately placed back from Scottsdale Road. Building articulation and stepped massing promote a natural hierarchy of the built form.

9. The design of the built environment should respond to the desert environment.

Response: The proposed development will utilize a variety of desert appropriate textures and building finishes, incorporate architectural elements that provide solar shading and overhangs, and celebrate the Southwest climate by creating abundant outdoor living spaces and amenities for its residents. The private outdoor living spaces proposed with this project far exceed the City requirements ranging from approximately 200 s.f. to 1,000 s.f.

As noted above, Artesia's design concept from a site improvement perspective is resort residential. A series of well linked outdoor rooms connect the resident to a variety of active and passive recreational spaces for the enjoyment of residents and guests. These spaces include pools, water features, fire features, solid roof shade structures, outdoor barbeques and outdoor kitchens. The planting design will complement the architecture, is more sun tolerant on the perimeter loop road and more shade tolerant in the internal courtyards due to the solar orientation of the 4-story structures. The importance of pedestrian linkage to connect this parcel to adjacent retail, restaurant and recreational amenities is well recognized and will be a critical component of the project's success. Landscaping is an important part of the Artesia resort-like environment and has been designed in a manner that enhances the pedestrian realm and emphasizes shaded walkways and shaded amenity areas in response to the desert environment.

This response also relates to number 11 & 12. Below.

10. Developments should strive to incorporate sustainable and healthy building practices and products.

Response: Sustainable strategies and building techniques, which minimize environmental impact and reduce energy consumption, will be emphasized. Green building will provide eco-friendly construction methods and materials, good ventilation design, breathable walls, and use of natural, non-toxic products and materials. The exploration and use of solar fields on the rooftops is underway as well.

11. *Landscape design should respond to the desert environment by utilizing a variety of mature landscape materials indigenous to the arid region.*

Response: Context appropriate, mature arid-region plant materials will be utilized with the development of PA-1. The desert character will be upheld through the careful selection of plant materials in terms of scale, density, and arrangement. See Landscape plan.

12. *Site design should incorporate techniques for efficient water use by providing desert adapted landscaping and preserving native plants.*


Response: The proposed development will maintain a low-water use plant palette. Context appropriate desert plant materials will be utilized with the development of the Property, consistent with the established vegetative pattern for Artesia and along Scottsdale Road (see Landscape Plan).

13. *The extent and quality of lighting should be integrally designed as part of the built environment.*

Response: Lighting has been designed in a manner that is respectful of the surrounding context while maintaining safety for future residents. See Lighting Plan and Photometric Plan.

14. *Signage should consider the distinctive qualities and character of the surrounding context in terms of size, color, location and illumination.*

Response: Project identification will be contextually appropriate and processed under a separate approval and permit process.

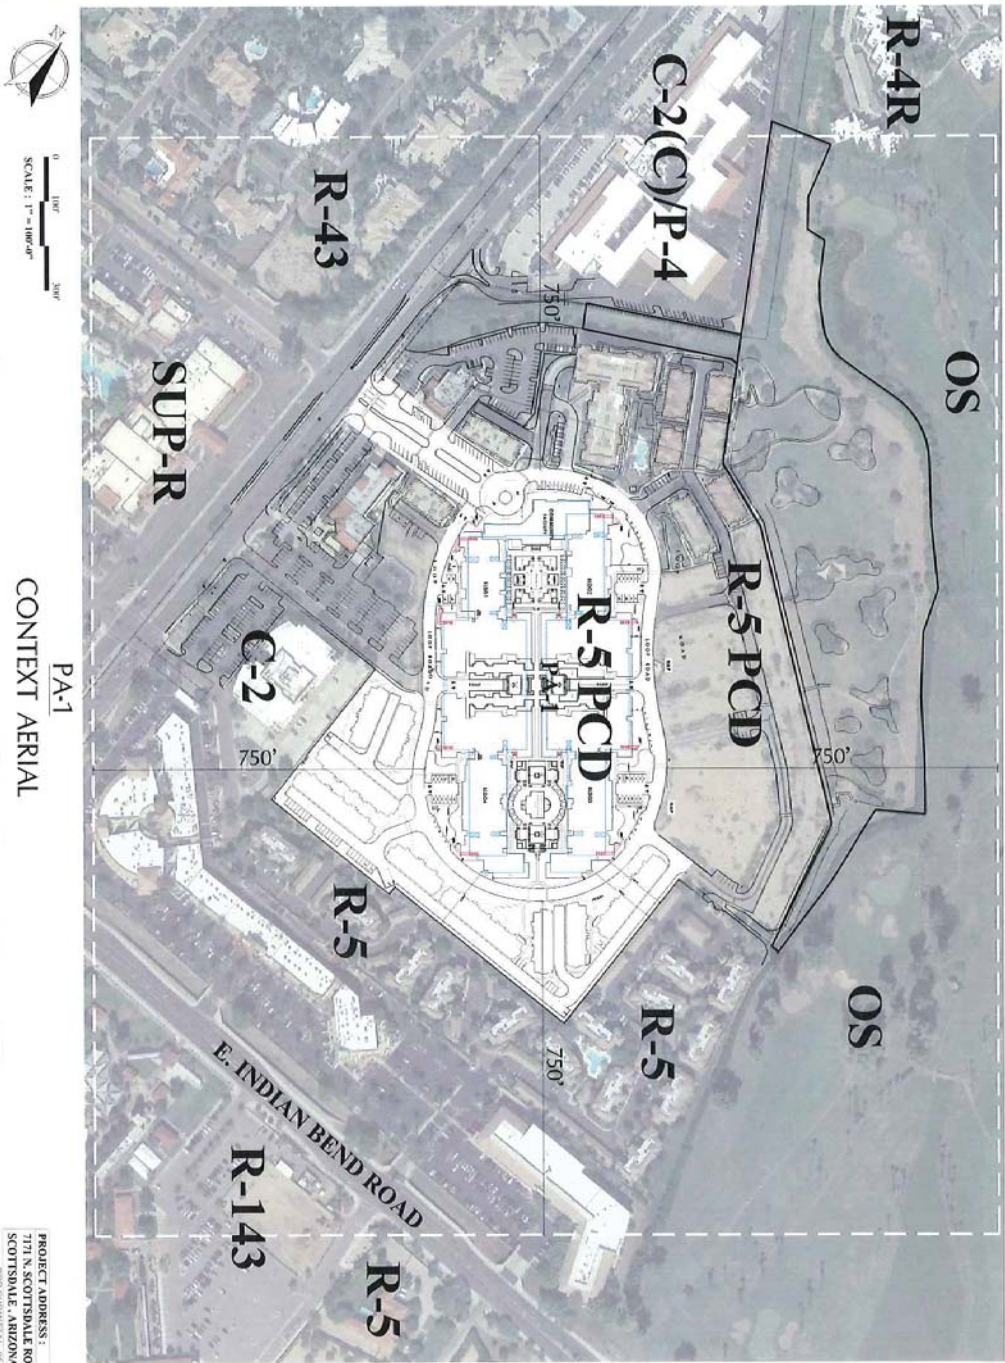

PA-1
CONTEXT AERIAL

PROJECT ADDRESS:
7171 N. SCOTTSDALE ROAD
SCOTTSDALE, ARIZONA
0869 SUBMITTAL 06-20-17

16-DR-2017
6/2/2017

SP-20

DATE	DESCRIPTION
05/17	PRELIMINARY

PERMIT NUMBER:
BCA No. 15029

DATE/TIME:
PA1 / PA3
CONTEXT AERIAL
PLAN

DATE/TIME:




OWNER:
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SCOTTSDALE, ARIZONA

ARCHITECT:
BUCCIA GROUP ARCHITECTURE

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Artesia

Illustrative Master Plan

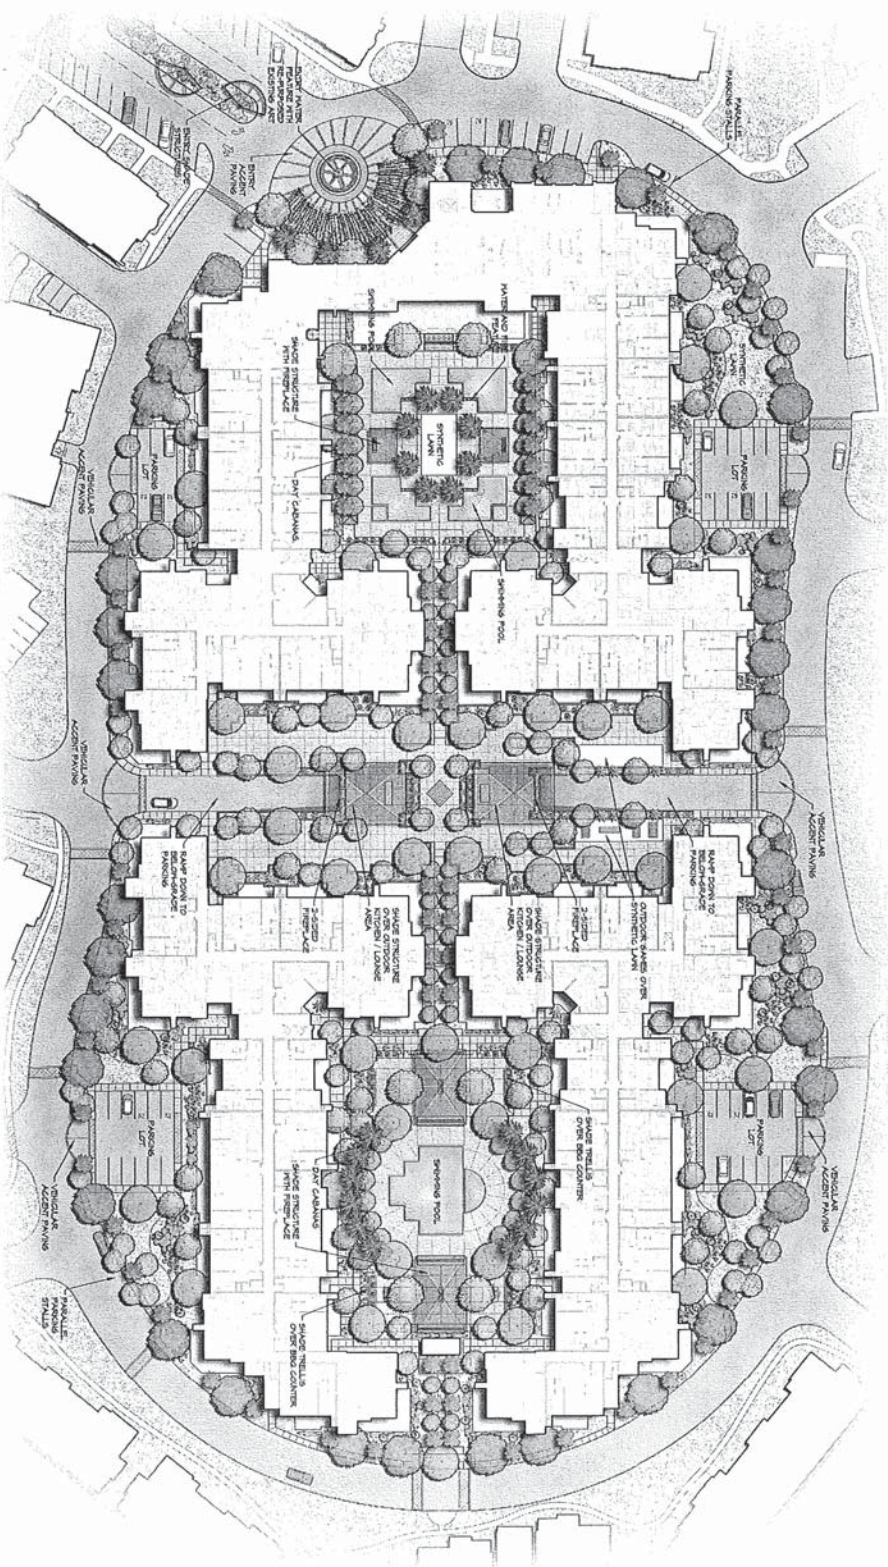
Scottsdale, AZ
 July 23, 2017



L-1.0

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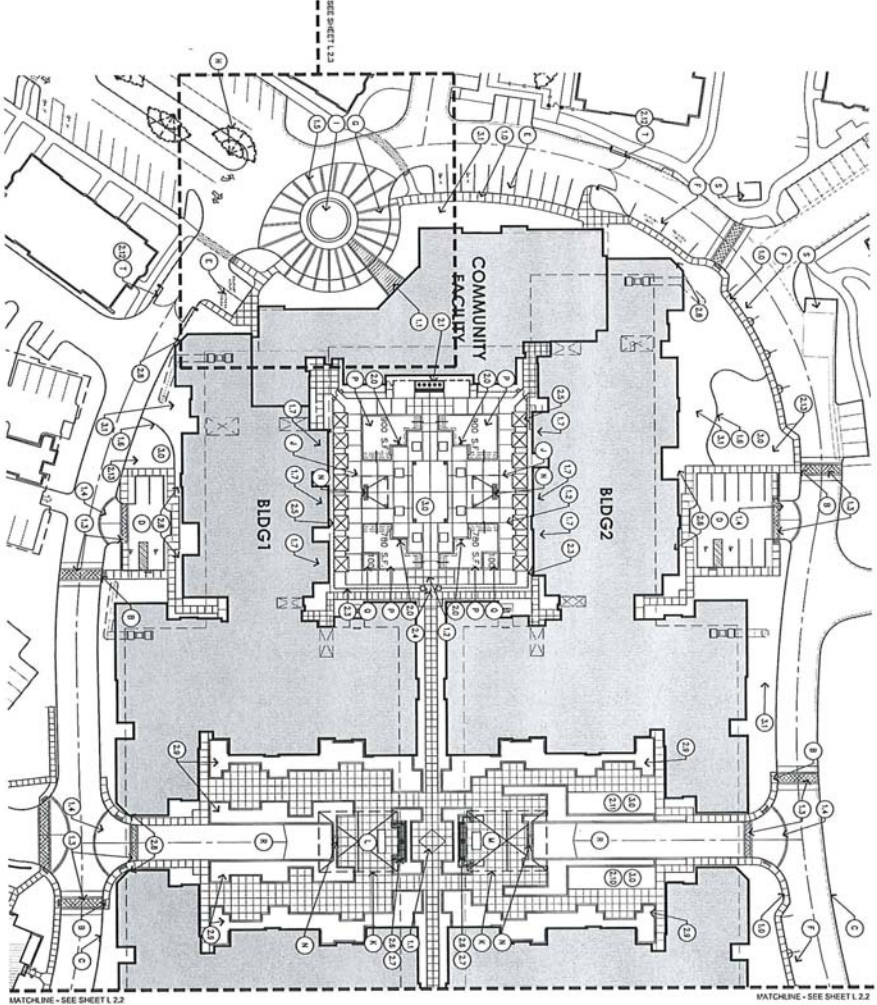
Antecia

Hardscape Plan - Overall

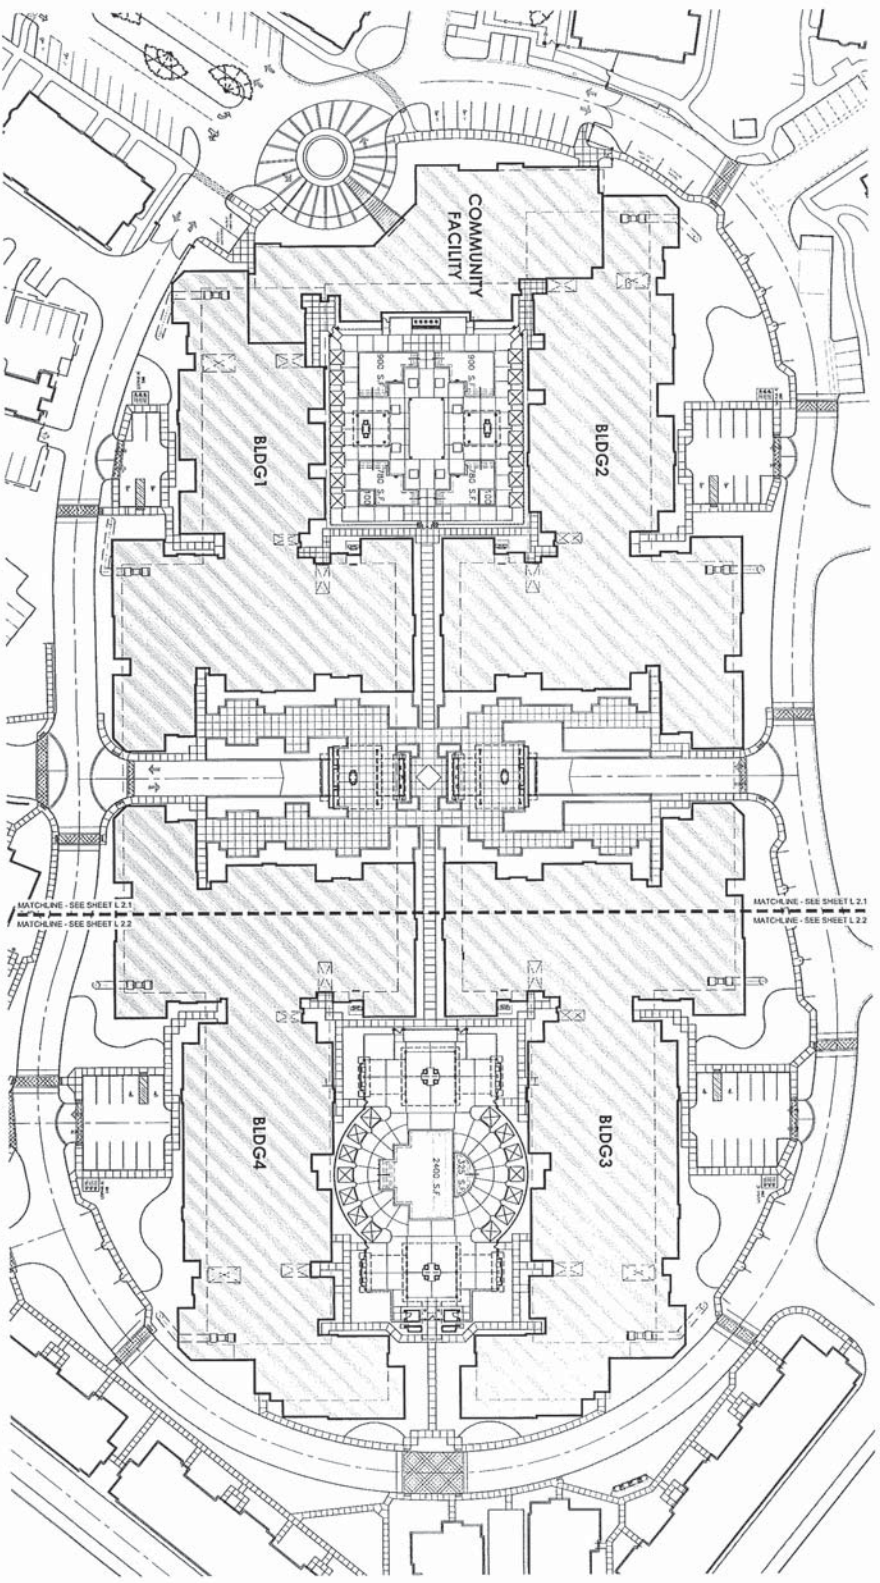

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HARDSCAPE KEYNOTES

1	EXISTING CONDITIONS / EXISTING INFRASTRUCTURE
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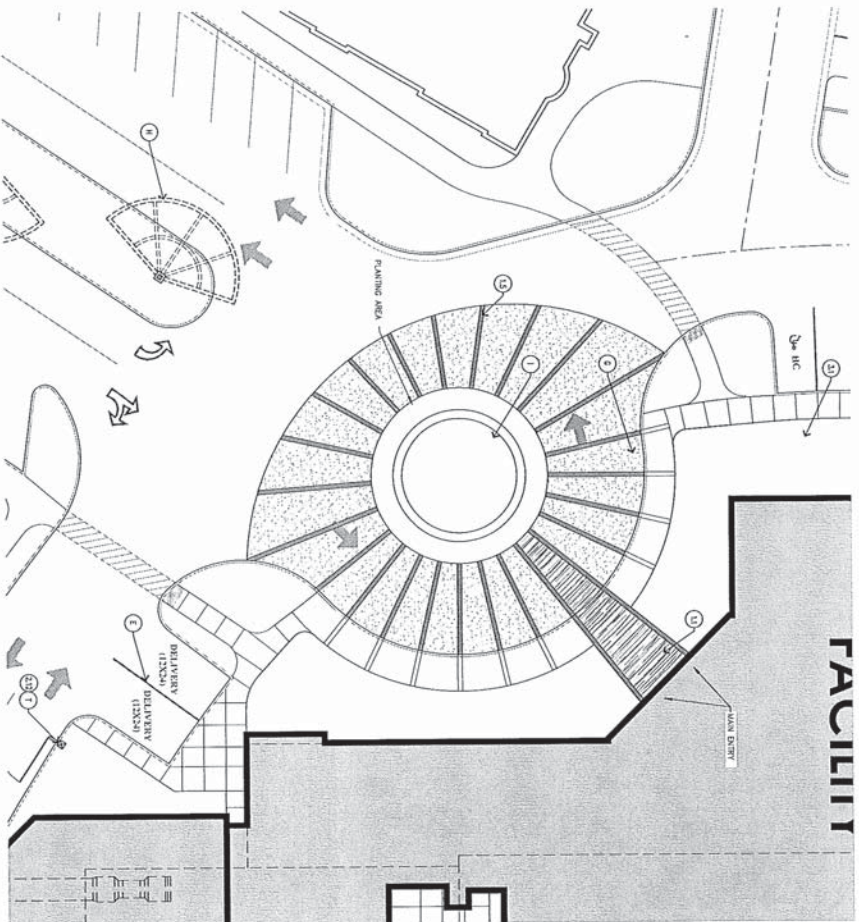
Antesia

Hardscape Plan - North End

Scale: 1" = 30'-0" @ 24"x36"

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 7/13/17



HARDSCAPE KEYNOTES

KEYNOTE	SYMBOL	DETAIL	DESCRIPTION
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96	○	EXISTING	EXISTING
97	○	EXISTING	EXISTING
98	○	EXISTING	EXISTING
99	○	EXISTING	EXISTING
100	○	EXISTING	EXISTING

Antesia


Landscape Plan - Enlarged Plan at Vehicle Accent Paving

BGA Buccia Group Architecture
 Buccia Group Architecture
 19732 MacArthur Blvd., Suite 270
 Irvine, CA 92614
 Phone: 949.851-8800
 www.bg-architecture.com

Scottsdale Road & Indian Bend Road
 Scottsdale, AZ 85258
 Scale: 1" = 10'-0" @ 28" x 36"

otak landscape architecture
 urban design
 511 West Third Street, Suite 201
 Phoenix, AZ 85002-6919
 www.otak.com

16-DR-2017
 7/13/17

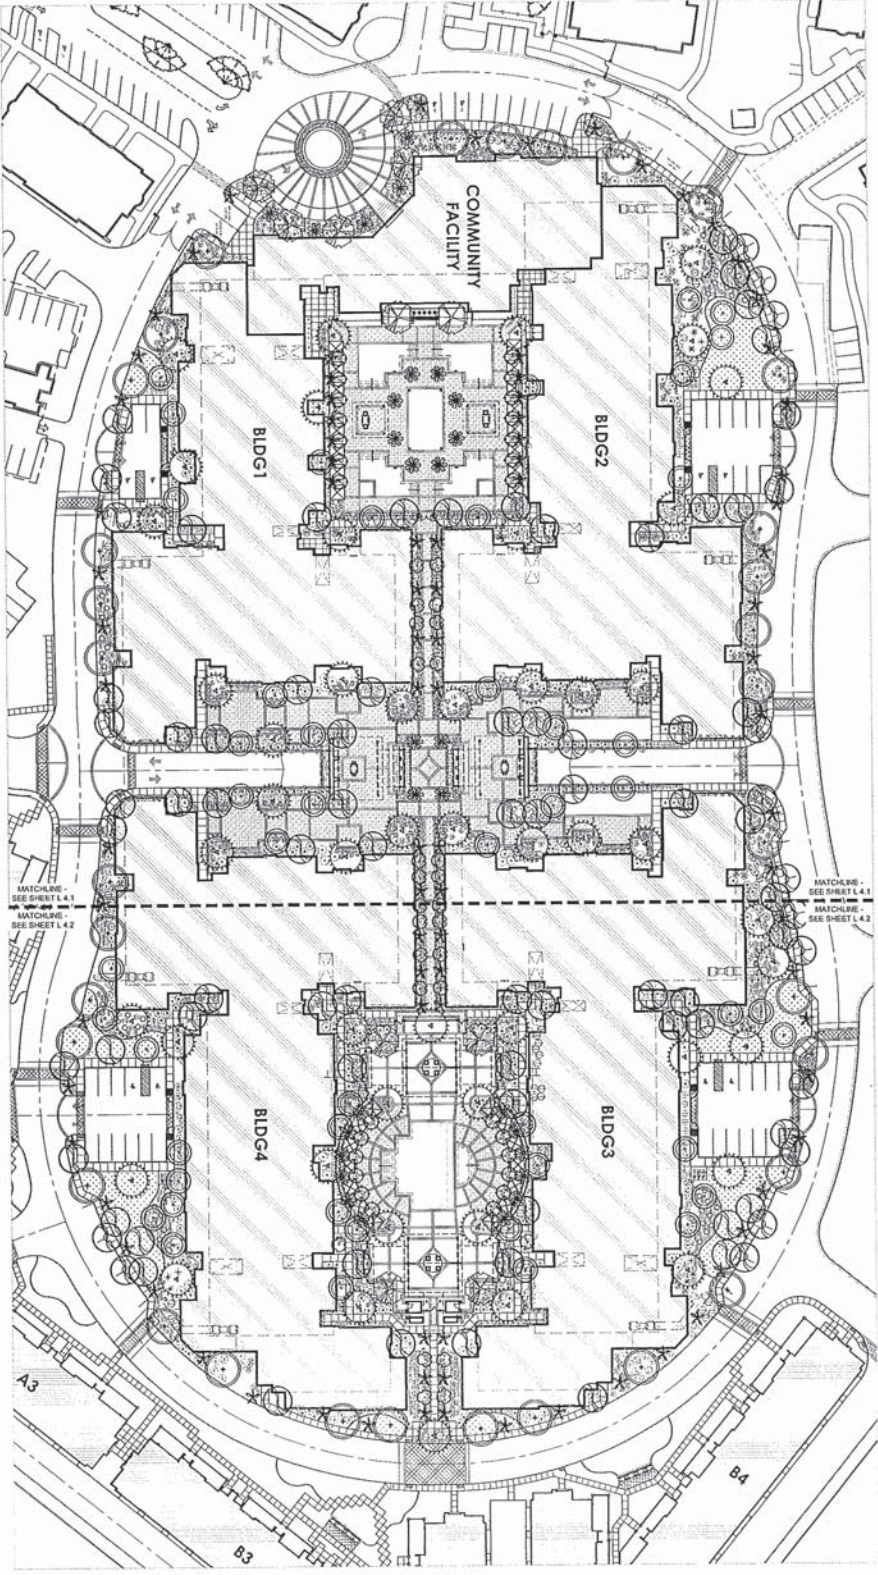

BGA Buccella Group Architecture

Buccella Group Architecture
 19782 MacArthur Blvd., Suite 270
 Phoenix, AZ 85028
 Phone: 480-551-5888
 www.bg-architecture.com

Antesia


Landscape Plan - Overall

Scottsdale Road & Indian Bend Road
 Scottsdale, AZ
 May 15, 2017



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 urban design
 51 North 17th Street, Suite 201
 Phoenix, AZ 85003-4822
 www.otak.com

16-DR-2017
 7/13/17

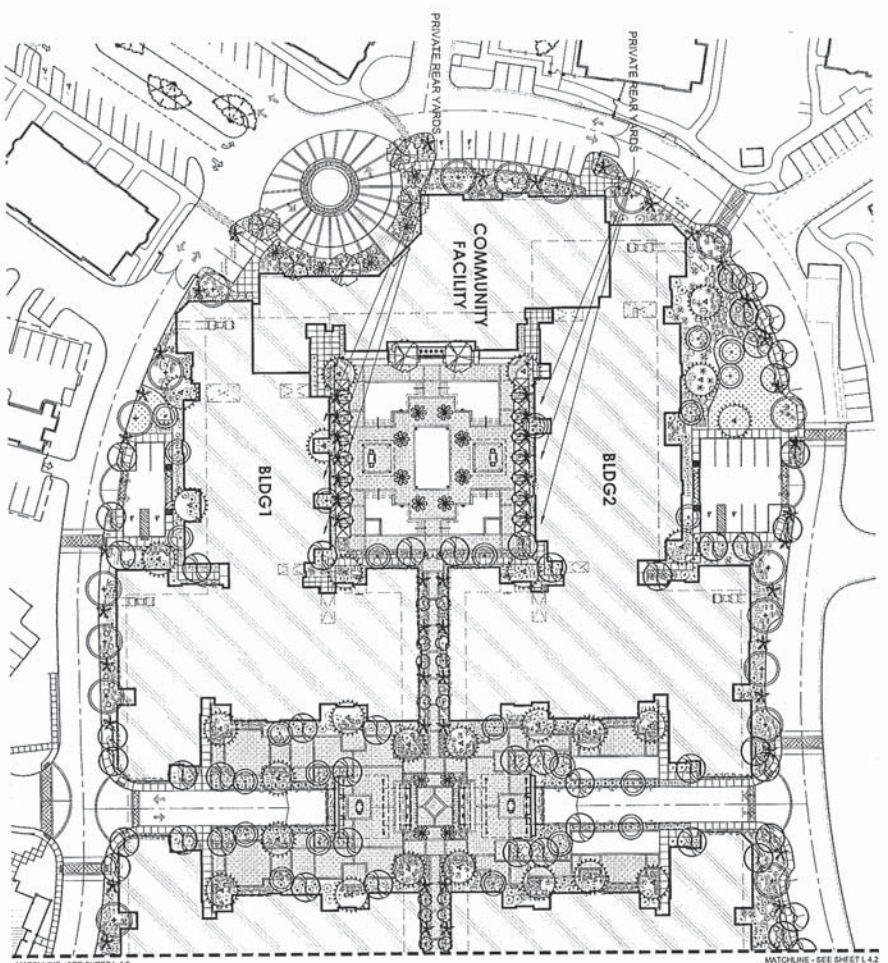

MATCHLINE - SEE SHEET L.4.2

PLANTING LEGEND

SYMBOL	DESCRIPTION	QUANTITY	SIZE	PRICE
(Symbol)	Planting	1	12"	1.00
(Symbol)	Planting	2	18"	2.00
(Symbol)	Planting	3	24"	3.00
(Symbol)	Planting	4	36"	4.00
(Symbol)	Planting	5	48"	5.00
(Symbol)	Planting	6	60"	6.00
(Symbol)	Planting	7	72"	7.00
(Symbol)	Planting	8	84"	8.00
(Symbol)	Planting	9	96"	9.00
(Symbol)	Planting	10	108"	10.00
(Symbol)	Planting	11	120"	11.00
(Symbol)	Planting	12	132"	12.00
(Symbol)	Planting	13	144"	13.00
(Symbol)	Planting	14	156"	14.00
(Symbol)	Planting	15	168"	15.00
(Symbol)	Planting	16	180"	16.00
(Symbol)	Planting	17	192"	17.00
(Symbol)	Planting	18	204"	18.00
(Symbol)	Planting	19	216"	19.00
(Symbol)	Planting	20	228"	20.00
(Symbol)	Planting	21	240"	21.00
(Symbol)	Planting	22	252"	22.00
(Symbol)	Planting	23	264"	23.00
(Symbol)	Planting	24	276"	24.00
(Symbol)	Planting	25	288"	25.00
(Symbol)	Planting	26	300"	26.00
(Symbol)	Planting	27	312"	27.00
(Symbol)	Planting	28	324"	28.00
(Symbol)	Planting	29	336"	29.00
(Symbol)	Planting	30	348"	30.00
(Symbol)	Planting	31	360"	31.00
(Symbol)	Planting	32	372"	32.00
(Symbol)	Planting	33	384"	33.00
(Symbol)	Planting	34	396"	34.00
(Symbol)	Planting	35	408"	35.00
(Symbol)	Planting	36	420"	36.00
(Symbol)	Planting	37	432"	37.00
(Symbol)	Planting	38	444"	38.00
(Symbol)	Planting	39	456"	39.00
(Symbol)	Planting	40	468"	40.00
(Symbol)	Planting	41	480"	41.00
(Symbol)	Planting	42	492"	42.00
(Symbol)	Planting	43	504"	43.00
(Symbol)	Planting	44	516"	44.00
(Symbol)	Planting	45	528"	45.00
(Symbol)	Planting	46	540"	46.00
(Symbol)	Planting	47	552"	47.00
(Symbol)	Planting	48	564"	48.00
(Symbol)	Planting	49	576"	49.00
(Symbol)	Planting	50	588"	50.00
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(Symbol)	Planting	52	612"	52.00
(Symbol)	Planting	53	624"	53.00
(Symbol)	Planting	54	636"	54.00
(Symbol)	Planting	55	648"	55.00
(Symbol)	Planting	56	660"	56.00
(Symbol)	Planting	57	672"	57.00
(Symbol)	Planting	58	684"	58.00
(Symbol)	Planting	59	696"	59.00
(Symbol)	Planting	60	708"	60.00
(Symbol)	Planting	61	720"	61.00
(Symbol)	Planting	62	732"	62.00
(Symbol)	Planting	63	744"	63.00
(Symbol)	Planting	64	756"	64.00
(Symbol)	Planting	65	768"	65.00
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(Symbol)	Planting	84	996"	84.00
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(Symbol)	Planting	88	1044"	88.00
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(Symbol)	Planting	97	1152"	97.00
(Symbol)	Planting	98	1164"	98.00
(Symbol)	Planting	99	1176"	99.00
(Symbol)	Planting	100	1188"	100.00

BGA Buccilla Group Architecture

Buccilla Group Architecture
19782 MacArthur Blvd., Suite 2710
Phoenix, AZ 85027
Phone: 602.951.4880
www.bg-architecture.com

Antesia


Landscape Plan - North End

Scale: 1" = 30'-0" @ 24"x36"

L.4.1

OTAK landscape architecture
urban design
111 North Third Street, Suite 201
Phoenix, AZ 85003-4213
www.otak.com

16-DR-2017
7/13/17

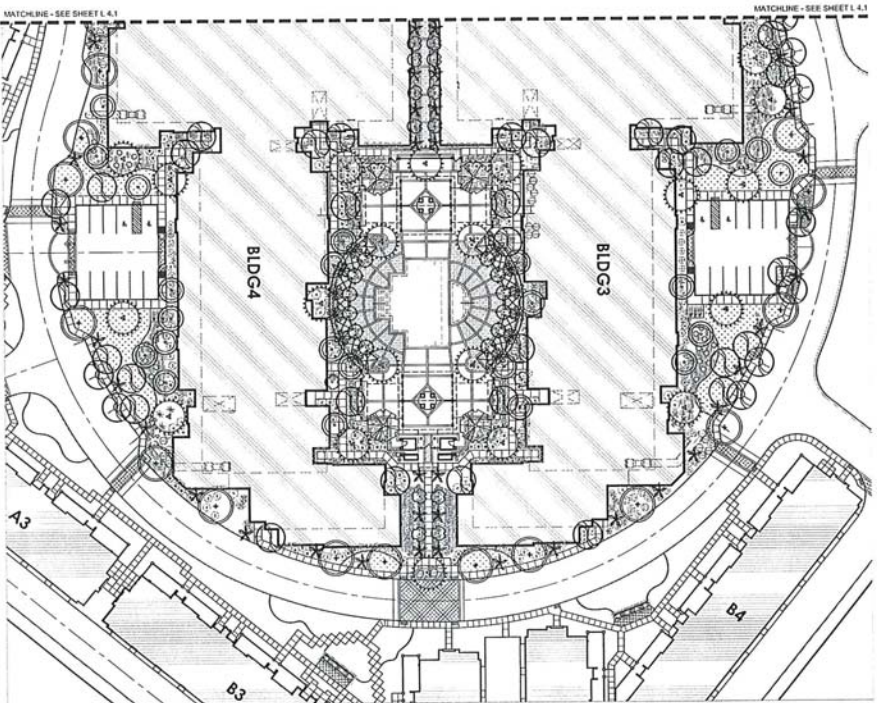

PLANTING LEGEND

SYMBOL	DESCRIPTION	QUANTITY	SIZE
○	Planting in landscape	1	12"
○	Planting in landscape	1	18"
○	Planting in landscape	1	24"
○	Planting in landscape	1	36"
○	Planting in landscape	1	48"
○	Planting in landscape	1	60"
○	Planting in landscape	1	72"
○	Planting in landscape	1	84"
○	Planting in landscape	1	96"
○	Planting in landscape	1	108"
○	Planting in landscape	1	120"
○	Planting in landscape	1	132"
○	Planting in landscape	1	144"
○	Planting in landscape	1	156"
○	Planting in landscape	1	168"
○	Planting in landscape	1	180"
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○	Planting in landscape	1	204"
○	Planting in landscape	1	216"
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○	Planting in landscape	1	240"
○	Planting in landscape	1	252"
○	Planting in landscape	1	264"
○	Planting in landscape	1	276"
○	Planting in landscape	1	288"
○	Planting in landscape	1	300"
○	Planting in landscape	1	312"
○	Planting in landscape	1	324"
○	Planting in landscape	1	336"
○	Planting in landscape	1	348"
○	Planting in landscape	1	360"
○	Planting in landscape	1	372"
○	Planting in landscape	1	384"
○	Planting in landscape	1	396"
○	Planting in landscape	1	408"
○	Planting in landscape	1	420"
○	Planting in landscape	1	432"
○	Planting in landscape	1	444"
○	Planting in landscape	1	456"
○	Planting in landscape	1	468"
○	Planting in landscape	1	480"
○	Planting in landscape	1	492"
○	Planting in landscape	1	504"
○	Planting in landscape	1	516"
○	Planting in landscape	1	528"
○	Planting in landscape	1	540"
○	Planting in landscape	1	552"
○	Planting in landscape	1	564"
○	Planting in landscape	1	576"
○	Planting in landscape	1	588"
○	Planting in landscape	1	600"
○	Planting in landscape	1	612"
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○	Planting in landscape	1	684"
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○	Planting in landscape	1	744"
○	Planting in landscape	1	756"
○	Planting in landscape	1	768"
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○	Planting in landscape	1	804"
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○	Planting in landscape	1	864"
○	Planting in landscape	1	876"
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○	Planting in landscape	1	900"
○	Planting in landscape	1	912"
○	Planting in landscape	1	924"
○	Planting in landscape	1	936"
○	Planting in landscape	1	948"
○	Planting in landscape	1	960"
○	Planting in landscape	1	972"
○	Planting in landscape	1	984"
○	Planting in landscape	1	996"
○	Planting in landscape	1	1008"

BGA Buccella Group Architecture

Buccella Group Architecture
 19782 MacArthur Blvd., Suite 210
 Irvine, CA 92614
 Phone: 949-451-9880
 www.bg-architecture.com

Antesia

Landscape Plan - South End

Scenic Road & Indian Blvd Road
 Schedule A2
 July 19, 2017




L 4.2

otak landscape architecture
 urban design
 51 West Third Street, Suite 201
 Phoenix, AZ 85003
 www.otak.com

16-DR-2017
 7/13/17



Shade Trees & Palm Trees

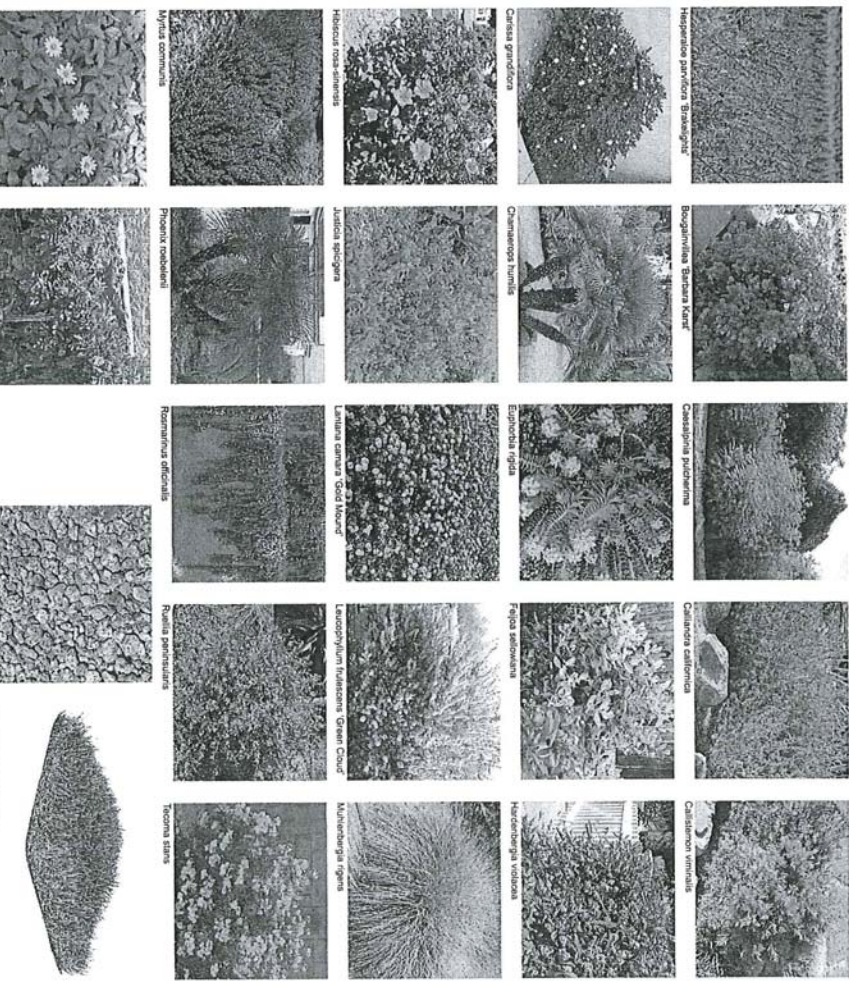

Shrubs, Vines, Accents, and Groundcovers

Inert Landscape Materials

Potter's Dirty Artificial Turf

BGA Buccella Group Architecture
 19782 Main Avenue Irvine, CA 92612
 Phone: 949-851-9080
 www.bg-architecture.com

Aestiva

Landscape Material & Imagery



Scottdale Road & Irbon Bond Road
 Scottsdale, AZ 85258 July 13, 2017

L 4.3

OTAK landscape architecture
 urban design

51 West Third Street, Suite 201
 Phoenix, AZ 85002-2693
 Phone: 602.277.0693
 www.otak.com


16-DR-2017
7/13/17

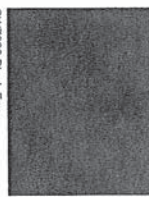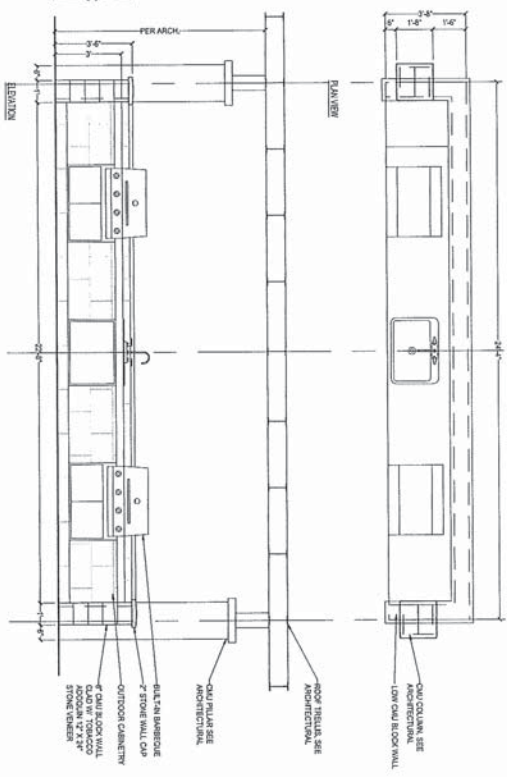


Material used at pool gate and fence posts, frames, and mesh panels. See details 2 & 7 on sheet US-0 of this set.




Material used at trellis structure. See detail 2 on sheet US-0 of this set.

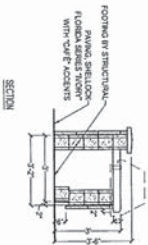

1 BARBEQUE TRELLIS
SCALE: 1/8"=1'-0"

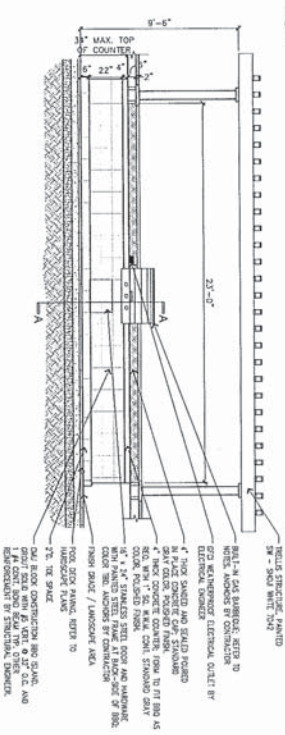

2 TRIPLE BBQ AT KITCHEN AREA RAMADAS
SCALE: 3/16"=1'-0"

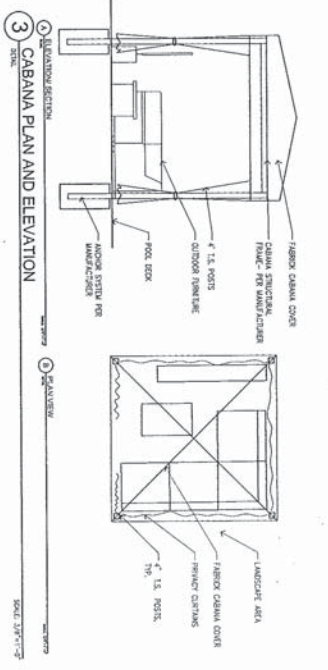

3 CABANA PLAN AND ELEVATION
SCALE: 3/16"=1'-0"

BGA Bucella Group Architecture
Bucella Group Architecture
19782 Mass Avenue, Suite 202
Boston, MA 02120
Phone: 617-552-1100
www.bg-architecture.com

Astoria
Design Details, Colors, & Materials


Scottingham Road & Indian Bend Road
Scottingham, MD 21150
410-391-2072
L 5.0

OTAK landscape architecture
urban design
51 Water Street, Suite 201
Boston, MA 02109
Phone: 617-452-6823
www.otak.com


16-DR-2017
7/13/17



④ LOW WALL SCALE 1/2"=1'-0"

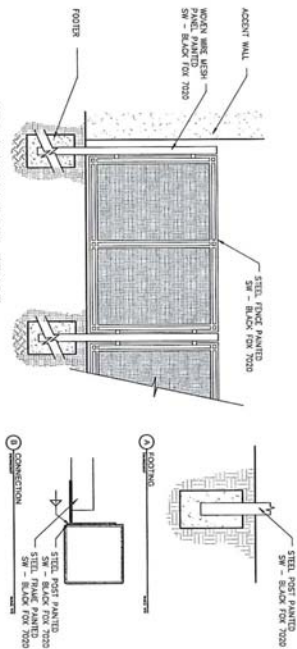


⑥ TYPICAL POOL FENCE SCALE 1/2"=1'-0"

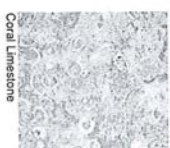


Coral Limestone

Material used at low walls and raised planter walls. See detail 4 & 5 on sheet L5.1 of this set.

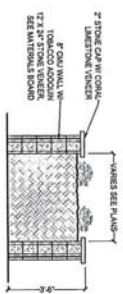

⑤ RAISED PLANTER WALLS SCALE 1/2"=1'-0"

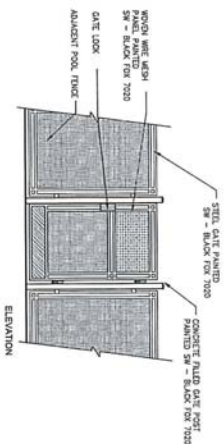

⑦ POOL ENTRY GATE/SECURITY FENCE (TYP.) SCALE 1/2"=1'-0"



Tobacco Adoquein

Material used at BBQ, outdoor structure, low walls, and raised planter walls. See detail 1 on sheet L5.0 and details 4, and 5 on sheet L5.1 of this set.

BGA Buella Group Architecture

Buella Group Architecture
19782 MacArthur Blvd, Suite 270
San Diego, CA 92128
Phone: 949-851-9880
www.bg-architecture.com


Artesia

Design Details, Colors, & Materials


Scotchdale Road & Indian Bend Road
Scotchdale, NC 28077
L 5.1

OTAK landscape architecture
urban design
51 West Third Street, Suite 201
San Diego, CA 92101
Phone: 619-592-8833
www.otak.com


16-DR-2017
7/13/17

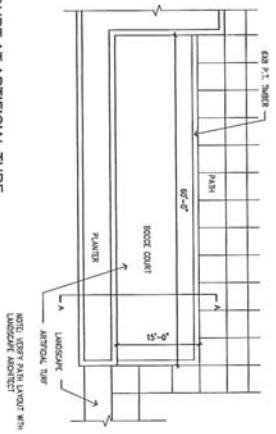


13 BOCCIE COURT AT ARTIFICIAL TURF
SECTION 101

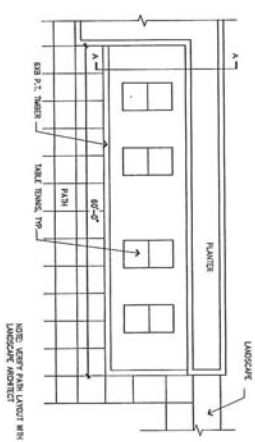

14 TABLE GAMES AT ARTIFICIAL TURF
SECTION 101

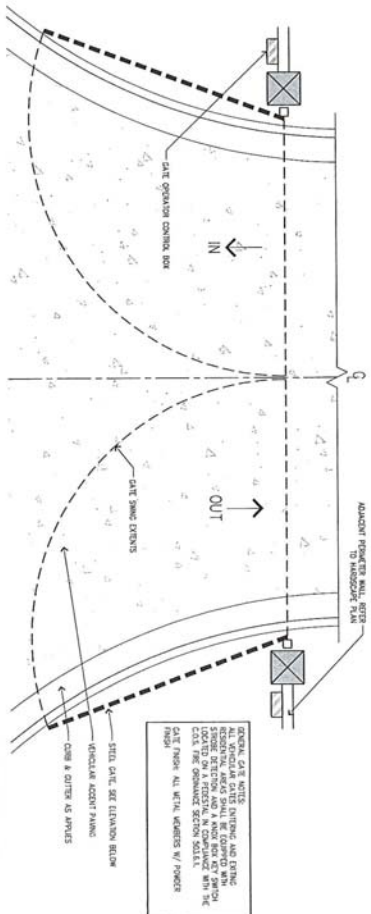

15 VEHICULAR GATE
SECTION 101

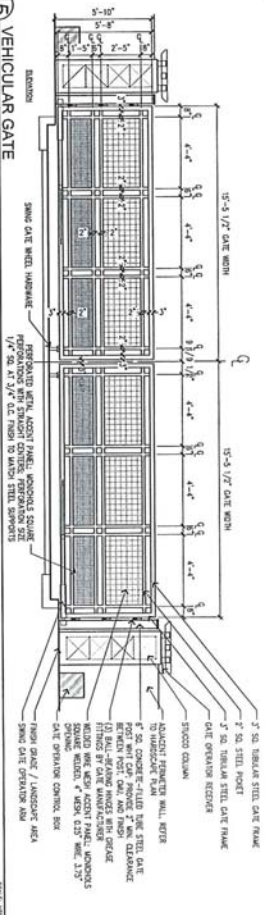

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19752 Massachusetts Blvd., CA 92612
Phone: 949-851-9080
www.bg-architecture.com

Bucella Group Architecture
19752 Massachusetts Blvd., CA 92612
Phone: 949-851-9080
www.bg-architecture.com

Artesia


Design Details, Colors, & Materials

Scarsdale Road & Indian Bend Road
Scottsdale, AZ 85257
July 13, 2017

L 5.3

OTAK landscape architecture
urban design
5111 West Third Street, Suite 201
Phoenix, AZ 85027-0203
www.otak.com

16-DR-2017
7/13/17

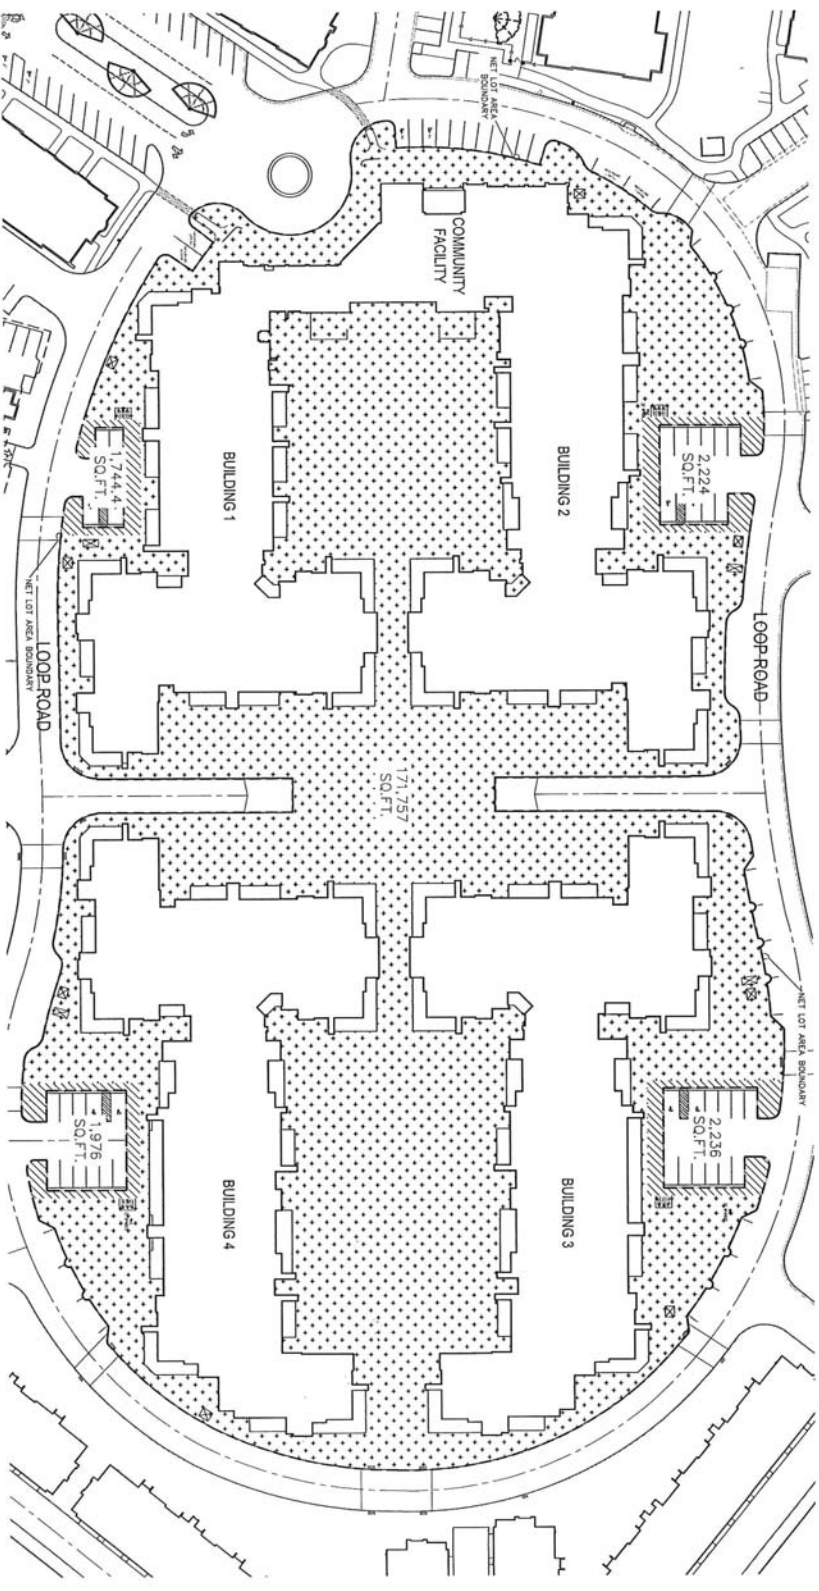

REQUIRED OPEN SPACE CALCULATIONS:
 NET LOT AREA (P+L) = 34,943 S.F.
 MAX. BUILDING HEIGHT = 50'-0"
 FIRST 17' OF HEIGHT = 108' x NET LOT AREA = 3,768 S.F.
 NEXT 30' OF HEIGHT = 20' x 208' x 34,943 = 50,000 S.F.

OPEN SPACE REQUIRED:
 OPEN BUILDING EXTERIOR LOT LANDSCAPING = 34,184 + 50,000 = 84,184 S.F. (-25% REQUIRED)
 17,129 SQ. FT. (74% PROVIDED)

EXTRAORDINARY LANDSCAPING REQUIRED CALCULATIONS:
 PARKING LOT AREA x 15% = 13,125 S.F. x 0.15 = 1,973 S.F. REQUIRED
 8,180 S.F. PROVIDED

RELIABLE OPEN LANDSCAPING:
 RIGHT-OF-WAY LANDSCAPING IS NOT APPLICABLE AS NO WHEN THE SCOPE OF THIS PROJECT

PARKING LOT LANDSCAPING:
 8,180.4 SQ. FT. PROVIDED

OPEN SPACE OTHER THAN FRONTAL OPEN SPACE:
 171,757.0 SQ. FT. PROVIDED

BGA Buccia Group Architecture

Buccia Group Architecture
 1782 MacArthur Blvd., Suite 270
 Irvine, CA 92614
 Phone: 949-851-8880
 www.bg-architecture.com



Artesia

Open Space Calculation Plan



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 51 West Third Street, Suite 201
 Irvine, CA 92612
 Phone: 949-261-0278
 www.otak.com

16-DR-2017
 7/13/17

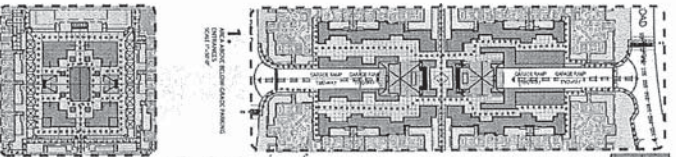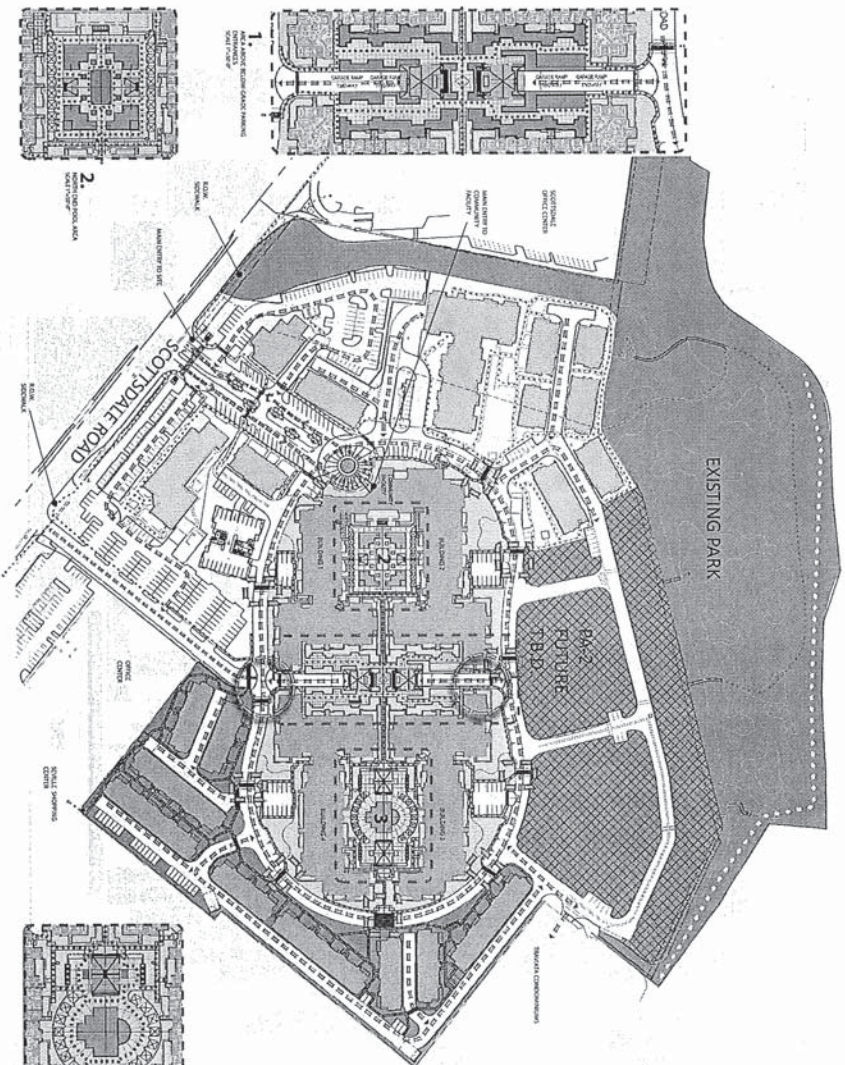

LEGEND

- PARKING GARAGE AT INTERSECTIONS
- PEDESTRIAN CROSSWALKS
- INTERIOR ROADS
- PROPOSED SIDEWALKS
- EXISTING SIDEWALKS
- PROPOSED TRAIL EASEMENT
- PROPOSED CROSSWALKS
- AREA PA-1
- AREA PA-2
- AREA PA-3
- PROPOSED BUILDING
- EXISTING BUILDING
- EXISTING PARK AND WASH



BGA Buccia Group Architecture
 Buccia Group Architecture
 19752 Main Street
 Irvine, CA 92612
 Phone 949-457-9080
 www.bga-architecture.com



Pedestrian Circulation Plan



Scottsdale Road & Indian Bend Road
 Scottsdale, AZ 85254
 July 13, 2017
 Scale: 1" = 80'-0" @ 24" x 36"



OTAK landscape architecture
 urban design
 511 West Third Street, Suite 201
 Phoenix, AZ 85003-0213
 Phone: 602-520-8213
 Fax: 602-520-8200

16-DR-2017
 7/13/17

COLOR MATERIALS	
1	Building - Veneer Ridge Building - Veneer Ridge
2	Facade Panel - Horizontal Veneer Facade Panel - Corner Fire Entry
3	DNV Corbel w/ Iron and Nickel Balcony Rail
4	Stone - Shading Wall Stone - Building Wall
5	Stone - Granite Walls w/ Iron cap Stone - First Corbel w/ Iron cap
6	Window / Door - Hardt Walls Window / Door - Clean Finish
7	Canopy - Door & Window
8	Building
9	Paint Colors Accent Color
10	Building Lighting
11	Roof - Flat
12	Roof - Pitch

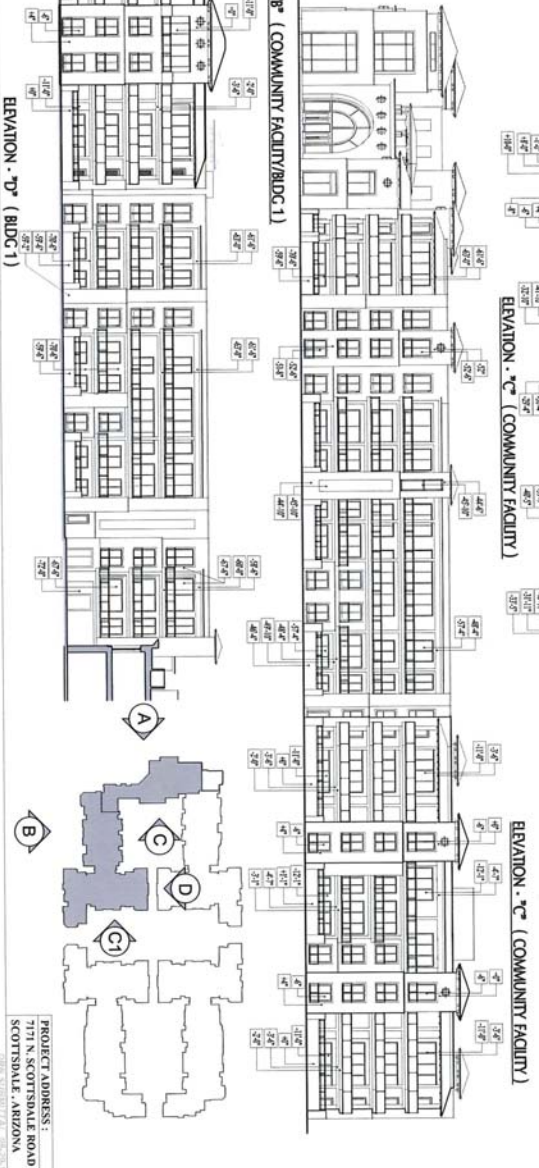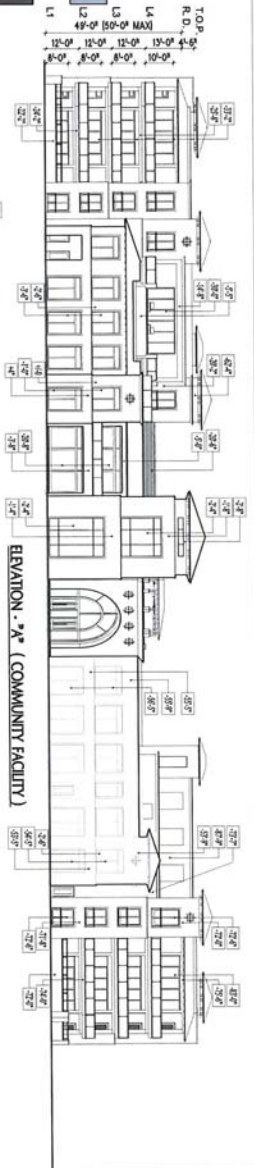

SCALE: 1/16" = 1'-0"

PROJECT ADDRESS:
717 N. SCOTTSDALE ROAD
SCOTTSDALE, ARIZONA

16-DR-2017
7/13/17

ARCHITECT: BRULLA GROUP ARCHITECTURE

PROJECT: ARTESIA THE SCOTTSDALE, ARIZONA

OWNER: ARTESIA DEVELOPMENT SCOTTSDALE, ARIZONA

BCA No. 15029



PROJECT ADDRESS: 717 N. SCOTTSDALE ROAD, SCOTTSDALE, ARIZONA

DATE: 7/13/17


SCALE: 1/16" = 1'-0"

16-DR-2017
7/13/17

COLOR MATERIALS	
1	Building - Wall Building - Wall Upper Building - Wall Lower
2	Finish Floor - Standard/Ventilator Finish Floor - Comm. Inc. Entry
3	20' Corridor w/ trim that extends Under Wall
4	Stucco - Building Wall Stucco - Building Wall Stucco - Building Wall
5	Stucco - Garden Walk w/ loose top Stucco - Front Corridor w/ loose top Under Floor - Board Walk Under Floor - Comm. Facility
6	Cladding - Door & Window
7	Building
8	Finish Ceiling Acoust. Ceiling
9	Building Lighting
10	Roof - Flat
11	Roof - Flat
12	Roof - Flat/Tile

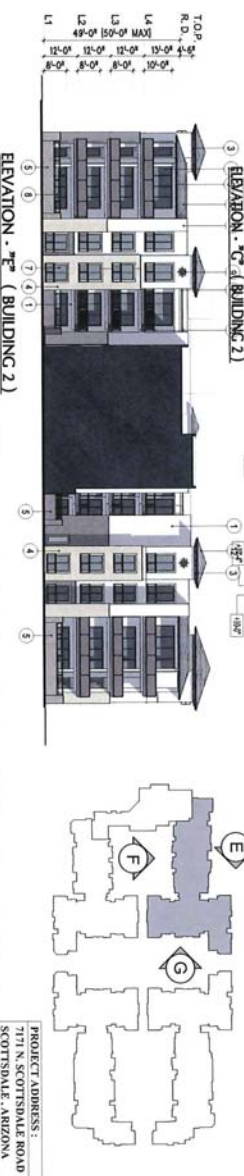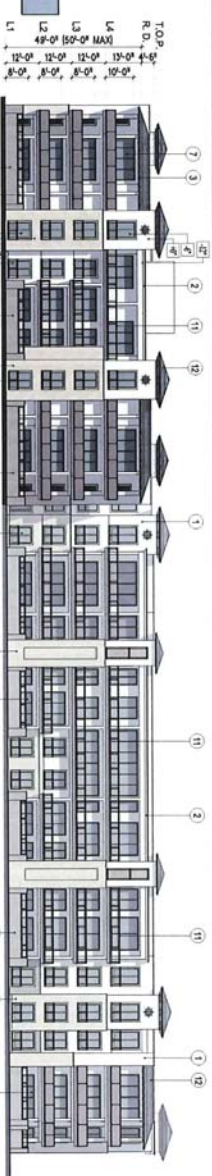

0 10' 20'
SCALE: 1/16" = 1'-0"

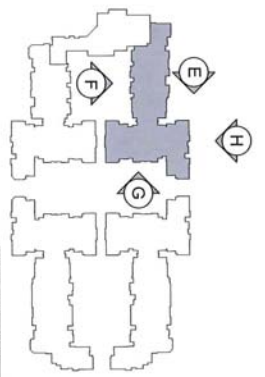

PROJECT ADDRESS:
771 N. SCOTTSDALE ROAD
SCOTTSDALE, ARIZONA
DATE SUBMITTED: 06-23-17

16-DR-2017
7/13/17

ARCHITECT
BUCELLA GROUP ARCHITECTURE
Architectural Group, Architects
1000 North Central Expressway, Suite 200
Scottsdale, Arizona 85261
Tel: 480.344.2200 Fax: 480.344.2201
www.buccella.com

STAMP

REGISTERED ARCHITECT
STATE OF ARIZONA
EXPIRES 06/30/18

Project:
ARTESIA
THE SCOTTSDALE
SCOTTSDALE, ARIZONA

Client:
ARTESIA DEVELOPMENT
SCOTTSDALE, ARIZONA

NO. DATE DESCRIPTION
1 06/23/17 PERMIT PREPARED
2 07/13/17 PERMIT SUBMITTAL

Sheet No.:
A-2.10

Project Number:
BCA No. 15029


Sheet Title:
BUILDING ELEVATIONS
BUILDING 2

COLOR MATERIALS

1	Building - Wall Building - Window Edge Building - Wall Veneer
2	Frame Form - Residential Veneer Frame Form - Commercial Entry
3	DN Outlook w/trim and Shaded Adhesive Wall
4	Stone - Building Wall Stone - Building Wall
5	Stone - Concrete Walk w/stone cap Stone - Frame Outlook w/stone cap
6	Window / Door - Shaded / Urea Window / Door - Cement / Ready
7	Cladding - Stone & Window
8	Roofing
9	Frame Outlook Accent Color
10	Building Lighting
11	Roof - Flat
12	Roof - Flat Tile




ELEVATION - "N" (BUILDING 4)

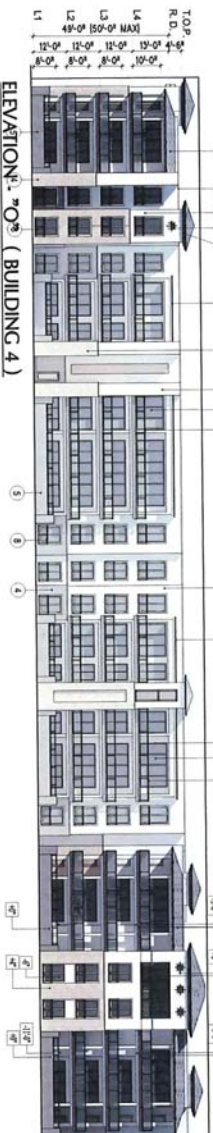

ELEVATION - "W" (BUILDING 4)




ELEVATION - "E" (BUILDING 4)

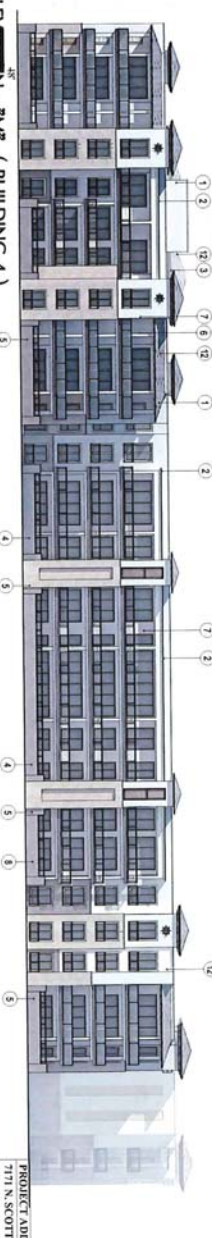

ELEVATION - "S" (BUILDING 4)

PROJECT ADDRESS:
3711 N. SCOTTSDALE ROAD
SCOTTSDALE, ARIZONA

Scale: 1/8" = 1'-0"

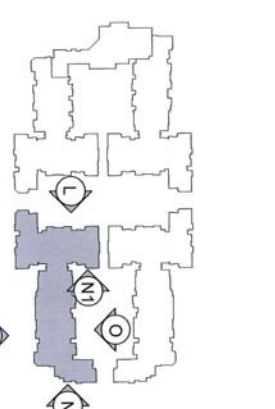

ARCHITECT
BUCILLA
GROUP
ARCHITECTURE

Architectural & Interior Architecture
1000 North Central Expressway, Suite 1000
Phoenix, Arizona 85004
Tel: 602.955.1100
Fax: 602.955.1101
www.bucillagroup.com

Stamp: [Professional Engineer Seal]

Project: ARTESIA 3711 N. SCOTTSDALE, ARIZONA

Owner: ARTESIA DEVELOPMENT NATIONAL, ARIZONA

Contract Description: ARCHITECTURAL DESIGN

Scale: 1/8" = 1'-0"

Sheet No.: A-4.10

Project No.: BCA No. 15029

Building Name: BUILDING BEHAVIORS BUILDING 4

16-DR-2017
7/13/17

RESIDENTIAL



- 12
- 3
- 11
- 2
- 7
- 6
- 10
- 4
- 8
- 1

COMMUNITY FACILITY



- 12
- 2
- 9
- 1
- 6
- 7

0 16'
SCALE: 3/16" = 1'-0"



- 12
- 3
- 9
- 8
- 1
- 6
- 7
- 8
- 4




- 12
- 3
- 1
- 2
- 9
- 4
- 6
- 7

PA-1
WALL ELEVATIONS & DETAILS

COLOR & MATERIAL SUMMARY

1	Roofing - Asphalt/Flt Shingles	1. 30 Year GAF Timberline HDZ
2	Exterior - Wall Finish	1. 3/8" Thick White Portland Cement Plaster over 1/2" Thick Metal Lath
3	Exterior - Paint	1. Sherwin Williams - PureColor® 1000 - Pure White
4	Exterior - Siding	1. 1/2" Thick White Vinyl Siding
5	Exterior - Trim	1. 1/2" Thick White Vinyl Siding
6	Exterior - Decking	1. 2x6 Composite Decking
7	Exterior - Stairs	1. 2x6 Composite Decking
8	Exterior - Balcony	1. 2x6 Composite Decking
9	Exterior - Windows	1. 1/2" Thick White Vinyl Siding
10	Exterior - Doors	1. 1/2" Thick White Vinyl Siding
11	Interior - Wall Finish	1. 5/8" Thick White Portland Cement Plaster over 1/2" Thick Metal Lath
12	Interior - Paint	1. Sherwin Williams - PureColor® 1000 - Pure White

BUILDING FINISHES

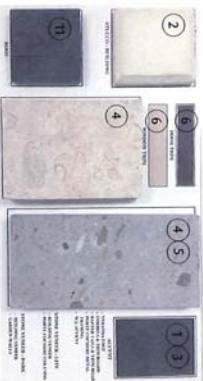

ARCHITECT:

BUCILLA GROUP ARCHITECTURE

1000 N. CENTRAL AVENUE, SUITE 100
SCOTTSDALE, ARIZONA 85257
TEL: 480.948.8888 FAX: 480.948.8889

OWNER:

ARTESIA DEVELOPMENT

1711 N. SCOTTSDALE ROAD
SCOTTSDALE, ARIZONA

DATE: 07/13/17

PROJECT: 16-DR-2017


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PROJECT ADDRESS:
1711 N. SCOTTSDALE ROAD
SCOTTSDALE, ARIZONA


BCA No. 15029

WALL ELEVATIONS & BUILDING MATERIALS

16-DR-2017
7/13/17

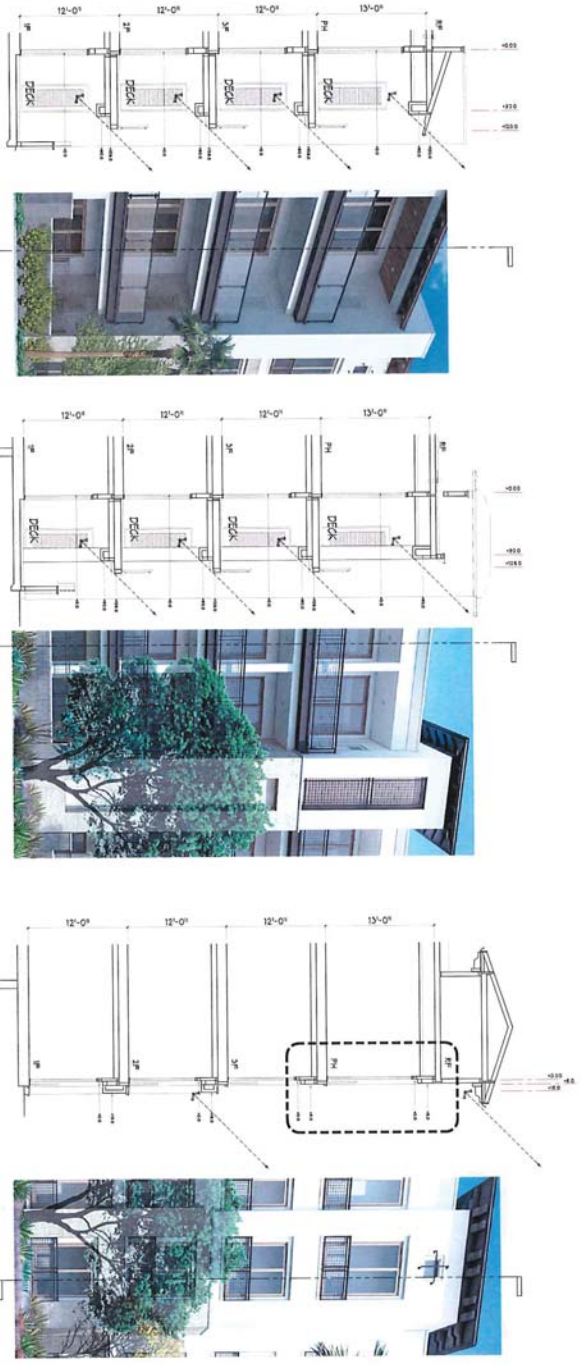


STANDARD WALL THICKNESS & RECESS
 - 5/8" OF 10" = 5"
 - 3/8" OF 10" = 3"

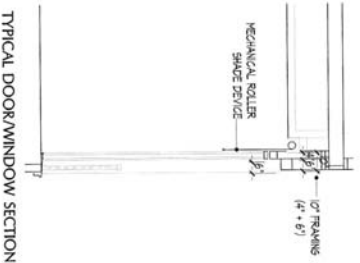

TYPICAL DOOR/WINDOW SECTION

RESIDENTIAL
 PA-1
 WALL ELEVATIONS
 & DETAILS

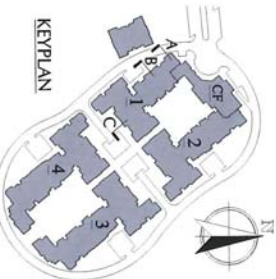

PROJECT ADDRESS:
 711 N. SCOTTSDALE ROAD
 SCOTTSDALE, ARIZONA
 DBL SUBMITTAL: 16-DR-2017

16-DR-2017
 7/13/17

ARCHITECT: **FUCILLA GROUP ARCHITECTURE**
 Architects, Planners, Engineers
 1711 N. SCOTTSDALE ROAD, SUITE 200, SCOTTSDALE, ARIZONA 85257
 TEL: 480.991.8888 FAX: 480.991.8889

OWNER: **ARTESIA DEVELOPMENT**
 7111 N. SCOTTSDALE, ARIZONA

PROJECT: **ARTESIA 7111 N. SCOTTSDALE, ARIZONA**




DATE: 07/13/17

NO. DATE DESCRIPTION
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 02 07/13/17 REVISED


PROJECT NUMBER: **BCA No. 15029**

ISSUED FOR: **RESIDENTIAL WALL ELEVATIONS & DETAILS**

SCALE: **SP-4.1**

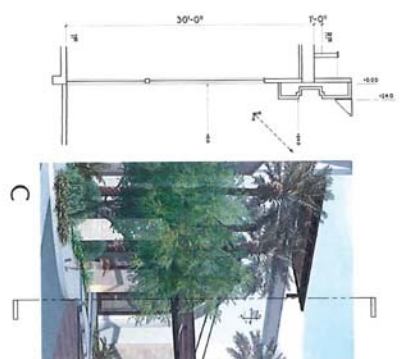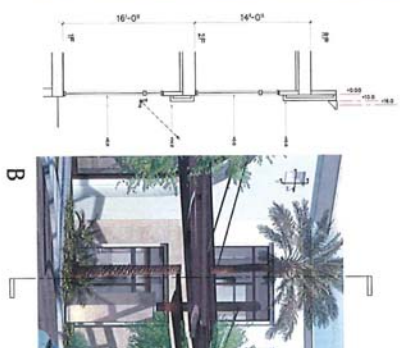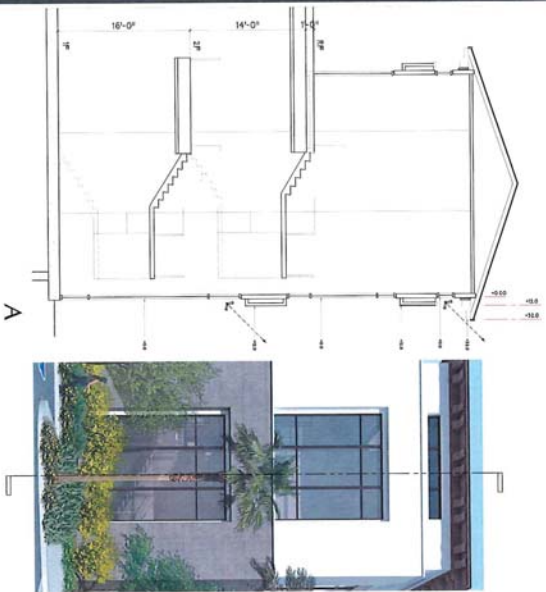


STANDARD WALL THICKNESS & RECESS
 - 5/8" OF 1/4" = 2"
 - 3/8" OF 1/4" = 3"

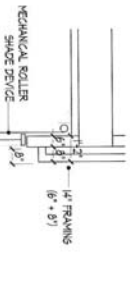

TYPICAL DOOR/WINDOW SECTION

SCALE: 3/16" = 1'-0"

COMMUNITY FACILITY
 PA-1
 WALL ELEVATIONS
 & DETAILS

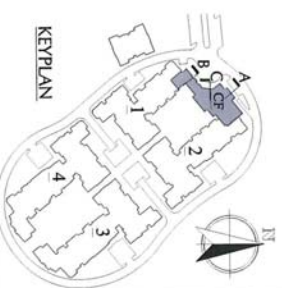

PROJECT ADDRESS:
 7711 N. SCOTTSDALE ROAD
 SCOTTSDALE, ARIZONA
 DRG SUBMITTAL REVISION

16-DR-2017
 7/13/17

ARCHITECT:
**BUCHLA
 & ROUP**
 ARCHITECTURE



PROJECT:
 ARTESIA
 COMMUNITY FACILITY
 SCOTTSDALE, ARIZONA

OWNER:
 ARTESIA DEVELOPMENT
 10000 N. SCOTTSDALE ROAD
 SCOTTSDALE, ARIZONA


DATE EXPIRES: 2017 SEP 30 09:00 AM

NO.	DATE	DESCRIPTION

PROJECT NUMBER:
 BCA No. 15029

ISSUED FOR:
 COMMUNITY FACILITY
 WALL ELEVATIONS
 & DETAILS

SCALE:
 SP-4.2

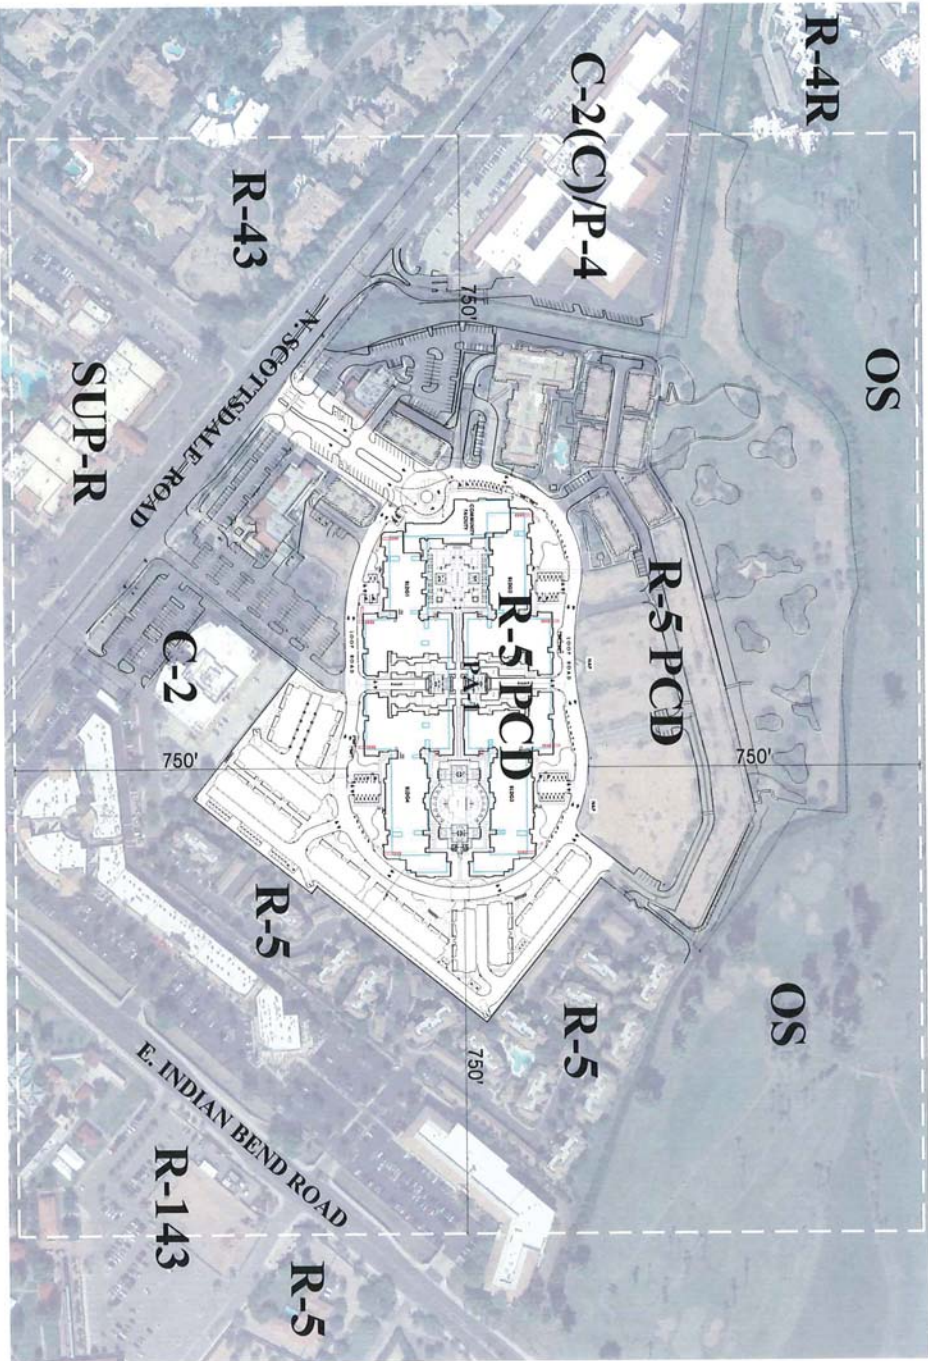

PA-1
CONTEXT AERIAL

PROJECT ADDRESS:
7171 N. SCOTTSDALE ROAD
SCOTTSDALE, ARIZONA
DING SUBMITTAL: 06-20-17

16-DR-2017
7/13/17

ARCHITECT
**BUCILLA
GROUP**
ARCHITECTURE
1600 N. CENTRAL AVENUE, SUITE 100
SCOTTSDALE, ARIZONA 85261
TEL: 480.948.8888 FAX: 480.948.8887
WWW.BUCILLAGROUP.COM



Project:
**ARTESIA
LAND
SCOTTSDALE, ARIZONA**

Owner:
**ARTESIA DEVELOPMENT
7171 N. SCOTTSDALE ROAD
SCOTTSDALE, ARIZONA**

CD DATE DESCRIPTION
2017 CD SUBMITTAL


REVISION NO.	DATE	DESCRIPTION

Project Number:
BCA No. 15029

Sheet Title:
PA1 / PA3
CONTEXT AERIAL
PLAN

Sheet No.:
SP-20

COLOR MATERIALS	
1	Building - Vertical Brick - 1/2" x 4" x 8"
2	Brick - Horizontal Brick - 1/2" x 4" x 8"
3	Brick - Vertical Brick - 1/2" x 4" x 8"
4	Brick - Vertical Brick - 1/2" x 4" x 8"
5	Brick - Vertical Brick - 1/2" x 4" x 8"
6	Brick - Vertical Brick - 1/2" x 4" x 8"
7	Brick - Vertical Brick - 1/2" x 4" x 8"
8	Brick - Vertical Brick - 1/2" x 4" x 8"
9	Brick - Vertical Brick - 1/2" x 4" x 8"
10	Brick - Vertical Brick - 1/2" x 4" x 8"
11	Brick - Vertical Brick - 1/2" x 4" x 8"
12	Brick - Vertical Brick - 1/2" x 4" x 8"

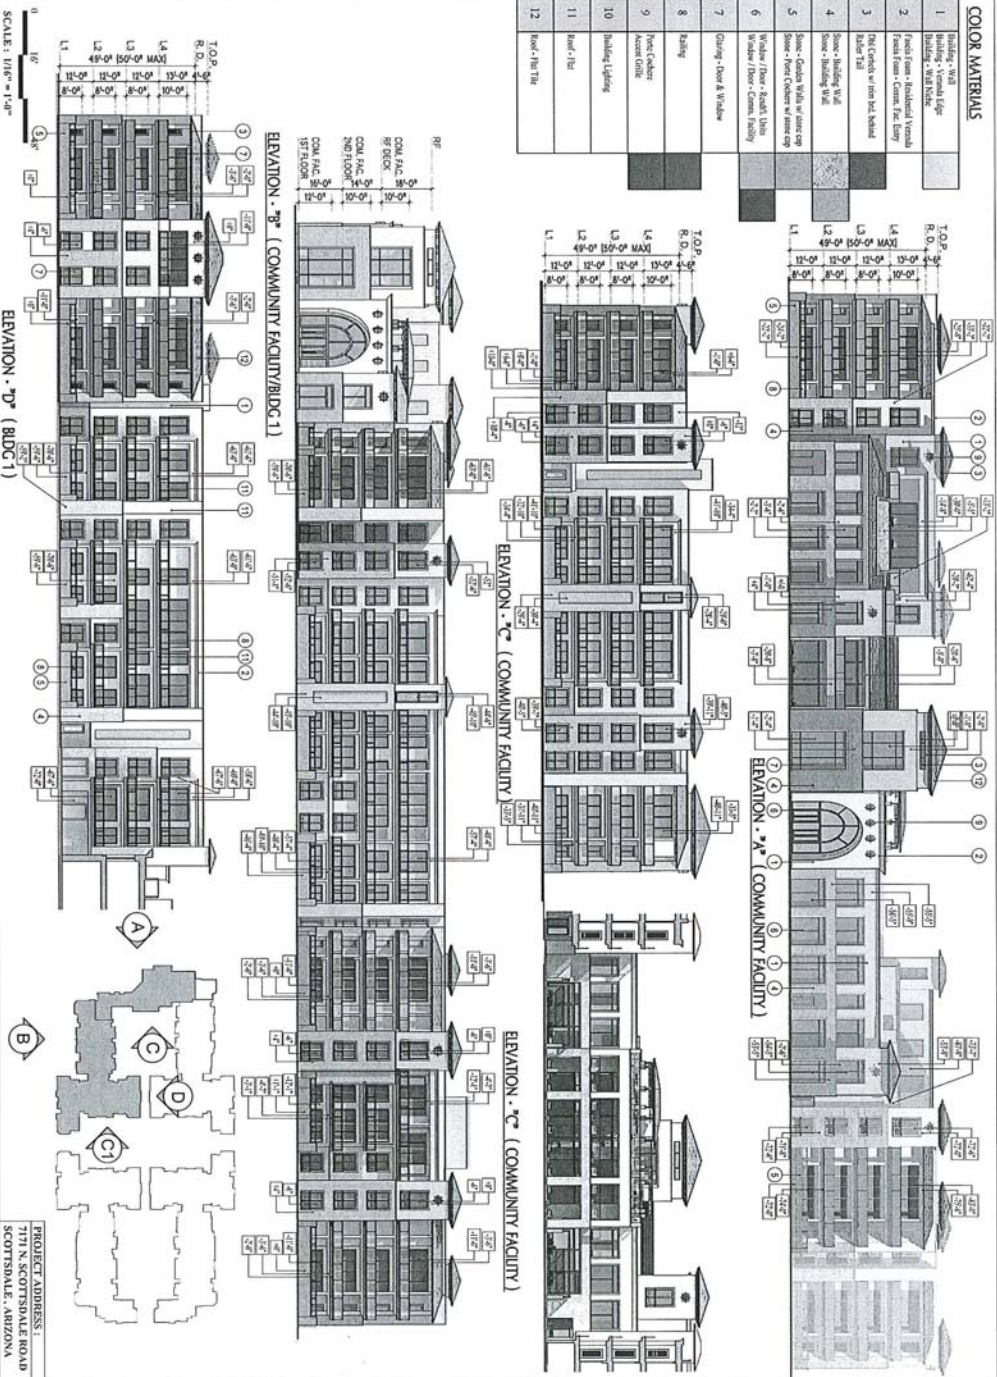

PROJECT ADDRESS:
7171 N. SCOTTSDALE ROAD
SCOTTSDALE, ARIZONA
DWSB SUBMITTAL: 06-25-17

16-DR-2017
7/13/17

ARCHITECT:
BUCILLA ROUP
ARCHITECTURE

ARCHITECTS: BUCILLA ROUP ARCHITECTURE
1111 N. SCOTTSDALE ROAD, SUITE 100
SCOTTSDALE, ARIZONA 85257
TEL: 480.344.1111 FAX: 480.344.1112
WWW.BUCILLARROUP.COM

PROJECT:
ARTESIA THE SCOTTSDALE
COMMUNITY FACILITY

DATE: 06-25-17

SCALE: 1/16" = 1'-0"

PROJECT NO.: 16-DR-2017

DATE: 06-25-17

BY: [Signature]




PROJECT ADDRESS:
7171 N. SCOTTSDALE ROAD
SCOTTSDALE, ARIZONA
DWSB SUBMITTAL: 06-25-17

BCA No. 15029

BUILDING ELEVATIONS
BUILDING 1 AND
COMMUNITY FACILITY

Sheet No.: A-110

COLOR MATERIALS	
1	Building - Wall Building - Window Sill
2	Roof - Flat - Residential Roof - Flat - Commercial Roof - Flat - Industrial
3	Roof - Flat - Residential Roof - Flat - Commercial Roof - Flat - Industrial
4	Roof - Flat - Residential Roof - Flat - Commercial Roof - Flat - Industrial
5	Roof - Flat - Residential Roof - Flat - Commercial Roof - Flat - Industrial
6	Roof - Flat - Residential Roof - Flat - Commercial Roof - Flat - Industrial
7	Roof - Flat - Residential Roof - Flat - Commercial Roof - Flat - Industrial
8	Roof - Flat - Residential Roof - Flat - Commercial Roof - Flat - Industrial
9	Roof - Flat - Residential Roof - Flat - Commercial Roof - Flat - Industrial
10	Roof - Flat - Residential Roof - Flat - Commercial Roof - Flat - Industrial
11	Roof - Flat - Residential Roof - Flat - Commercial Roof - Flat - Industrial
12	Roof - Flat - Residential Roof - Flat - Commercial Roof - Flat - Industrial

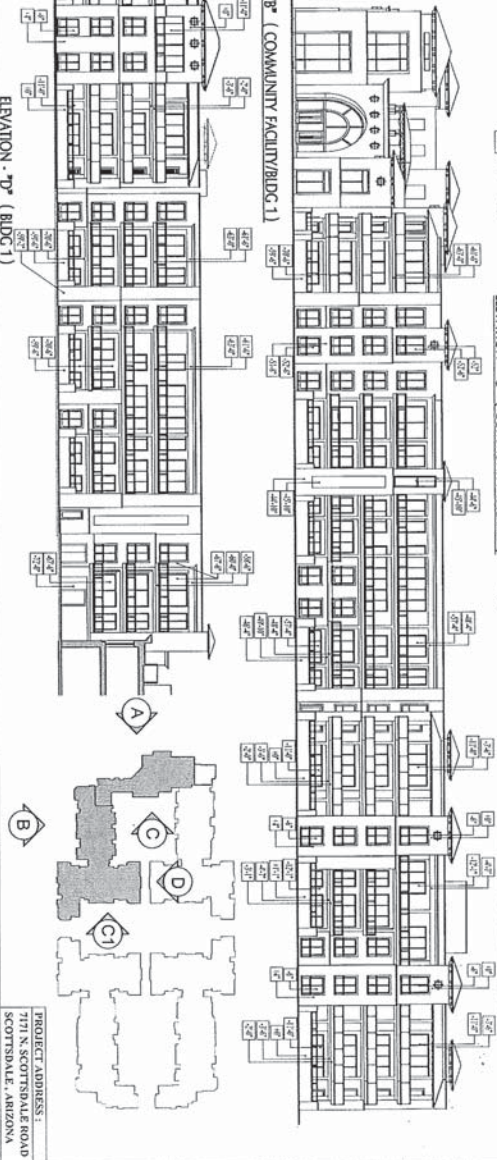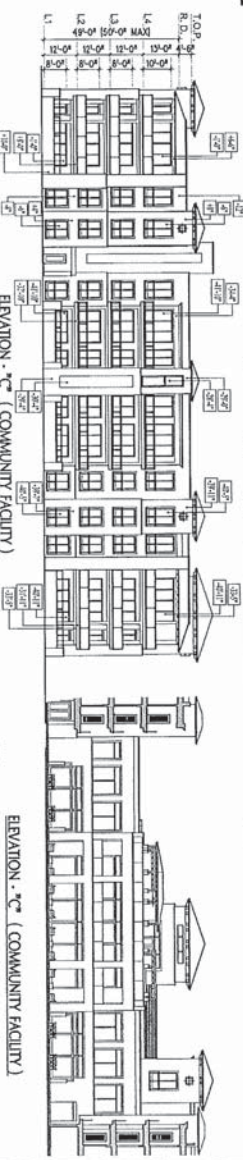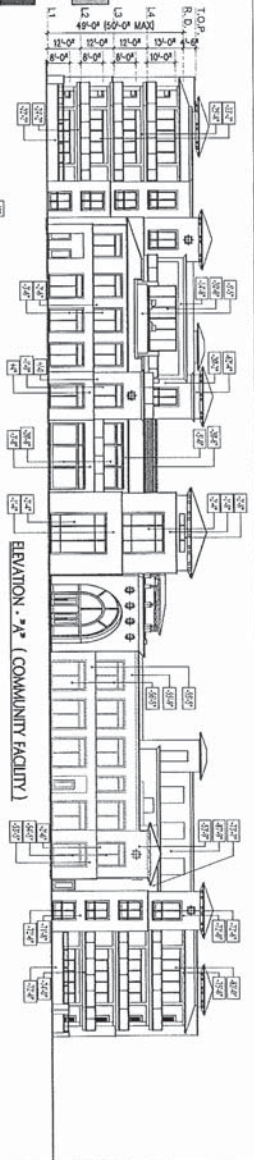

PROJECT ADDRESS:
7171 N. SCOTTSDALE ROAD
SCOTTSDALE, ARIZONA
DBS SUBMITTAL 06-35-17

BUCILLA GROUP ARCHITECTURE
 1000 N. CENTRAL AVENUE, SUITE 100
 SCOTTSDALE, ARIZONA 85261
 TEL: 480.948.8888
 FAX: 480.948.8889
 WWW.BUCILLAGROUP.COM




ARTESIA ARCHITECTURE
 1000 N. CENTRAL AVENUE, SUITE 100
 SCOTTSDALE, ARIZONA 85261
 TEL: 480.948.8888
 FAX: 480.948.8889
 WWW.ARTESIARCHITECTURE.COM

Project No: 15029
 Sheet Title:
 Building Elevations
 Building 1 and
 Community Facility
 Date: 7/13/17

A-1.10A


16-DR-2017
7/13/17

COLOR MATERIALS	
1	Building - Main Elevator Building - Main Elevator Building - Main Elevator
2	Roof Floor - Standard Thermal Roof Deck - Green PVC Deck
3	Door Curbles w/ Green Red Metalized Acrylic Film
4	Stone - Building Wall Stone - Building Wall Stone - Building Wall Stone - Building Wall Stone
5	Stone - Green Wall w/ Stone cap Stone - Green Wall w/ Stone cap
6	Window Floor - Acrylic Glass Window Floor - Acrylic Glass
7	Cladding - Stone & Window
8	Cladding
9	Paint Color - Green Glass
10	Building Lighting
11	Land / Site
12	Land / Pav / Tile

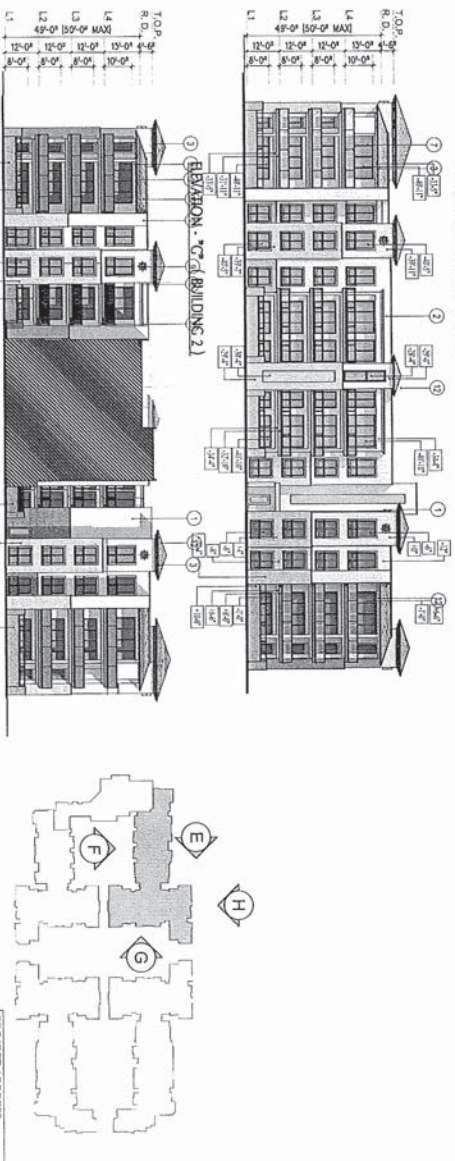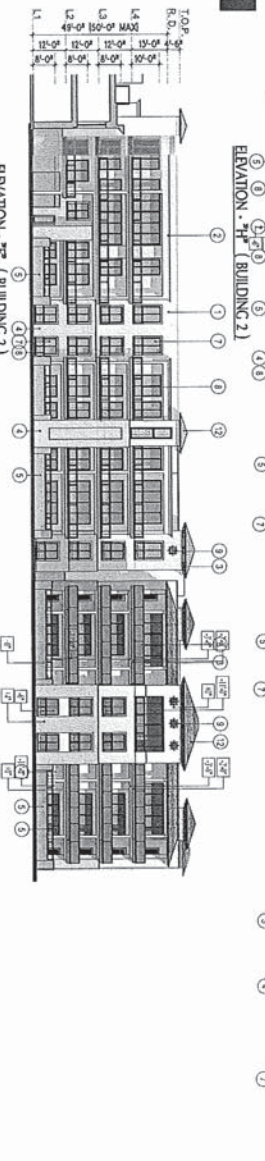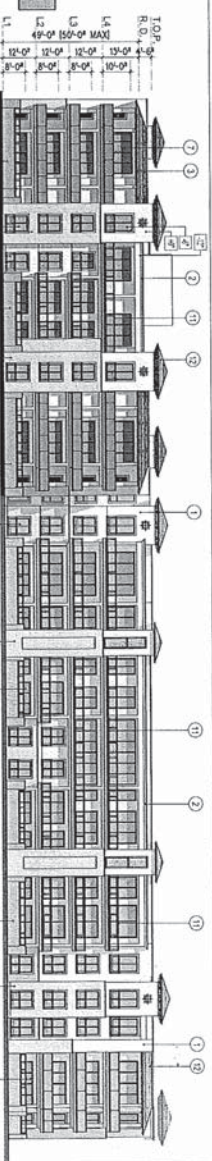

ELEVATION - F (BUILDING 2)

0 10' 20'
SCALE: 1/8" = 1'-0"

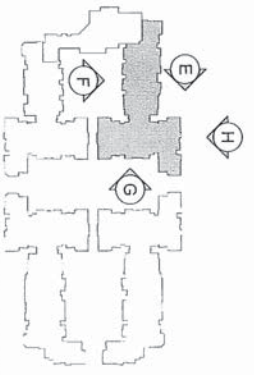

PROJECT ADDRESS:
771 N. SCOTTSDALE ROAD
SCOTTSDALE, ARIZONA
088-2108077AL-06-25-17

16-DR-2017
7/13/17

ARCHITECT
BUCILLA GROUP ARCHITECTURE
BUCILLA GROUP ARCHITECTURE
1000 N. CENTRAL AVENUE, SUITE 1000
PHOENIX, ARIZONA 85004
PH: 602.955.1100
WWW.BUCILLAGROUP.COM

PROJECT:
ARTESIA
PHASE 2
SCOTTSDALE, ARIZONA

OWNER:
ARTESIA DEVELOPMENT
SCOTTSDALE, ARIZONA

DATE: 06/25/17
DRAWN BY: [Name]
CHECKED BY: [Name]
SCALE: 1/8" = 1'-0"






Project Number:
BCA No. 15029

Sheet Title:
BUILDING ELEVATIONS
BUILDING 2

Sheet No.:
A-2.10

COLOR MATERIALS

1	Window - White	
2	Window - Vertical Sliding - White Noise	
3	Window - Horizontal Sliding - White Noise	
4	Window - Fixed - White Noise	
5	Window - Fixed - White Noise	
6	Window - Fixed - White Noise	
7	Window - Fixed - White Noise	
8	Window - Fixed - White Noise	
9	Window - Fixed - White Noise	
10	Window - Fixed - White Noise	
11	Window - Fixed - White Noise	
12	Window - Fixed - White Noise	

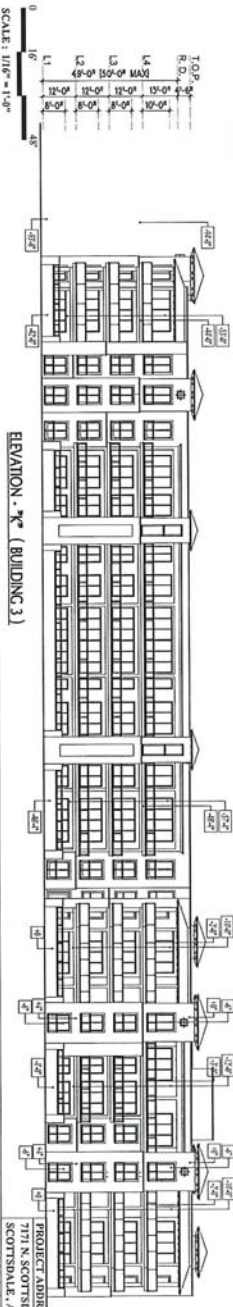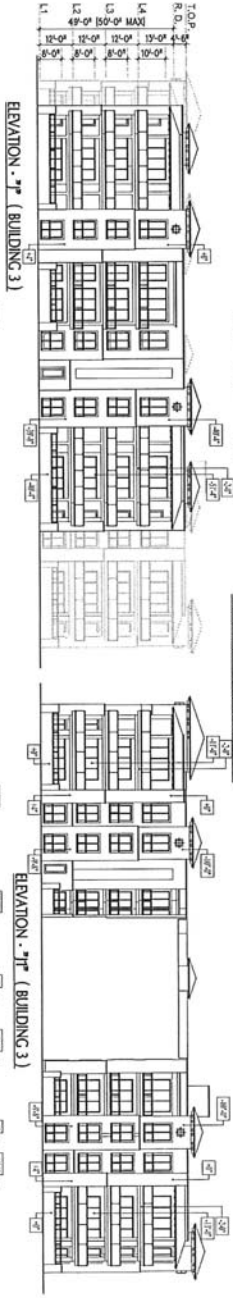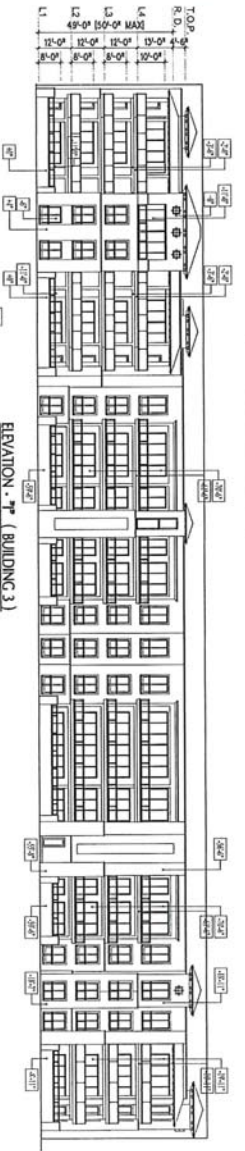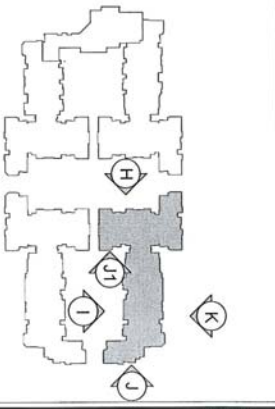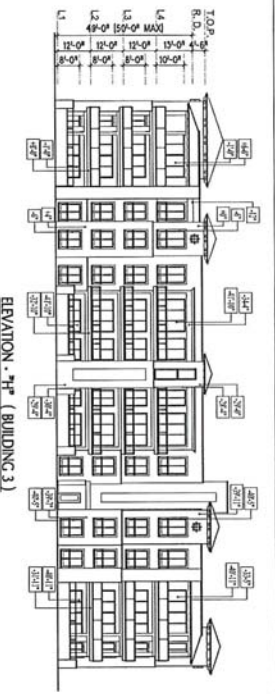

PROJECT ADDRESS:
7171 N. SCOTTSDALE ROAD
SCOTTSDALE, ARIZONA
DRG SUBMITTAL 06-2017

16-DR-2017
7/13/17

A-3.10A

Project: ARTESIA ROAD SCOTTSDALE, ARIZONA

Client: ARTESIA ROAD SCOTTSDALE, ARIZONA

Architect: BUCILLA GROUP ARCHITECTURE

Scale: 1/8" = 1'-0"






Sheet No: A-3.10A

Project No: 15029

Building Name: BUILDING 3

Scale: 1/8" = 1'-0"

COLOR MATERIALS	
1	Handing - Metal Handing - Wood Edge Handing - Wood Sides
2	French Brass - Horizontal Panels French Brass - Crown Fire Entry Zircon Tile
3	Stone - Building Wall
4	Stone - Building Wall
5	Stone - Crown Wall w/ stone cap Stone - French Corner w/ stone cap
6	Stainless Steel - Handrail Units Stainless Steel - Crown Facility
7	Galvanneal - Door & Windows
8	Painting
9	Paint - Crown Accent Color
10	Building Lighting
11	Roof - Flat
12	Roof - Flat Tile

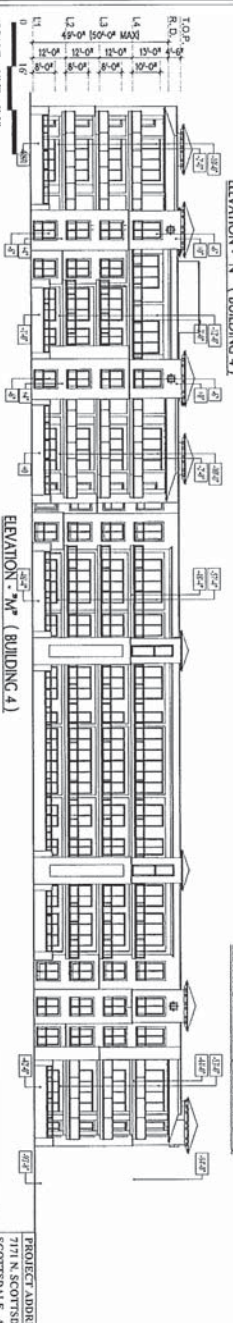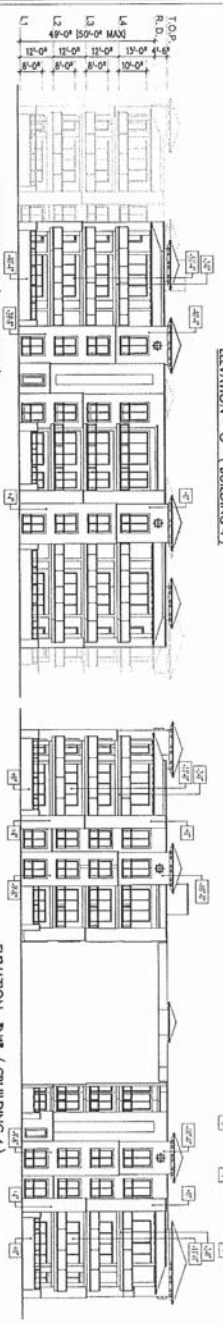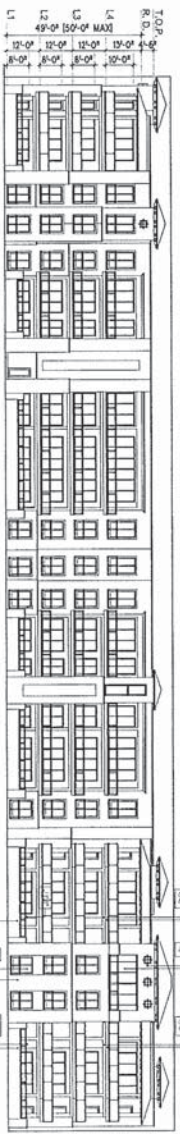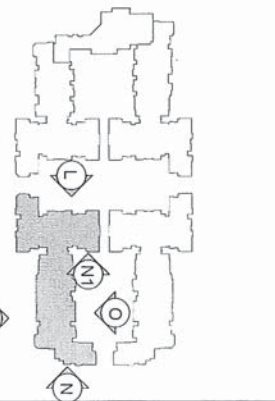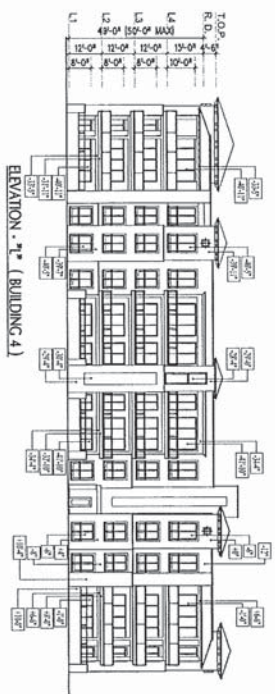

PROJECT ADDRESS:
7171 N. SCOTTSDALE ROAD
SCOTTSDALE, ARIZONA
DRB SUBMITTAL 06-23-17

Sheet No. **A-4.10A**
BCA No. 15029
Sheet Title: **BUILDING ELEVATIONS BUILDING 4**

16-DR-2017
7/13/17

ARCHITECT:
BOJILLA GROUP ARCHITECTURE
ARCHITECTS
10000 N. CENTRAL EXPRESSWAY, SUITE 100
SCOTTSDALE, ARIZONA 85258
TEL: 480.344.8800
WWW.BOJILLAGROUP.COM


PROJECT:
ARTSIA THEATRE SCOTTSDALE, ARIZONA

DATE: 06-23-17

SCALE: 1/8" = 1'-0"

NO.	DESCRIPTION	DATE	BY	CHECKED

RESIDENTIAL

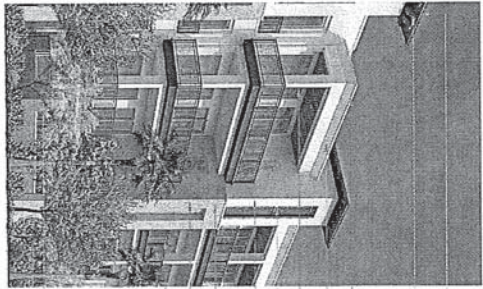


- 12
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- 11
- 2
- 7
- 6
- 10
- 4
- 8
- 5



- 12
- 3
- 9
- 8
- 1
- 6
- 7
- 4
- 8
- 5

COMMUNITY FACILITY

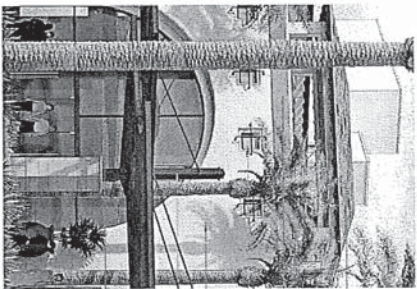

- 12
- 2
- 9
- 1
- 6
- 7



- 12
- 1
- 3
- 2
- 4
- 9
- 6
- 7

WALL ELEVATIONS & DETAILS
PA-1

PROJECT ADDRESS:
7171 N. SCOTTSDALE ROAD
SCOTTSDALE, ARIZONA
088 SUBMITTAL 06-25-17


SP-40

16-DR-2017
7/13/17

COLOR & MATERIAL SUMMARY

1	Exterior Wall Finish	1200 Series Smooth Stone Veneer, Random Set, 18" x 18" x 12"
2	Exterior Wall Finish	12" x 24" Smooth Stone Veneer, Random Set, 18" x 18" x 12"
3	Exterior Wall Finish	1200 Series Smooth Stone Veneer, Random Set, 18" x 18" x 12"
4	Exterior Wall Finish	1200 Series Smooth Stone Veneer, Random Set, 18" x 18" x 12"
5	Exterior Wall Finish	1200 Series Smooth Stone Veneer, Random Set, 18" x 18" x 12"
6	Exterior Wall Finish	1200 Series Smooth Stone Veneer, Random Set, 18" x 18" x 12"
7	Exterior Wall Finish	1200 Series Smooth Stone Veneer, Random Set, 18" x 18" x 12"
8	Exterior Wall Finish	1200 Series Smooth Stone Veneer, Random Set, 18" x 18" x 12"
9	Exterior Wall Finish	1200 Series Smooth Stone Veneer, Random Set, 18" x 18" x 12"
10	Exterior Wall Finish	1200 Series Smooth Stone Veneer, Random Set, 18" x 18" x 12"
11	Exterior Wall Finish	1200 Series Smooth Stone Veneer, Random Set, 18" x 18" x 12"
12	Exterior Wall Finish	1200 Series Smooth Stone Veneer, Random Set, 18" x 18" x 12"

BUILDING FINISHES

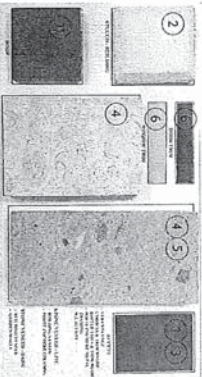

Client: ARTESIA DEVELOPMENT
7171 N. SCOTTSDALE ROAD
SCOTTSDALE, ARIZONA


Project: ARTESIA DEVELOPMENT
7171 N. SCOTTSDALE ROAD
SCOTTSDALE, ARIZONA

BCA No. 15029

Sheet Title: WALL ELEVATIONS & BUILDING MATERIALS

Scale: SP-40

Date: 7/13/17

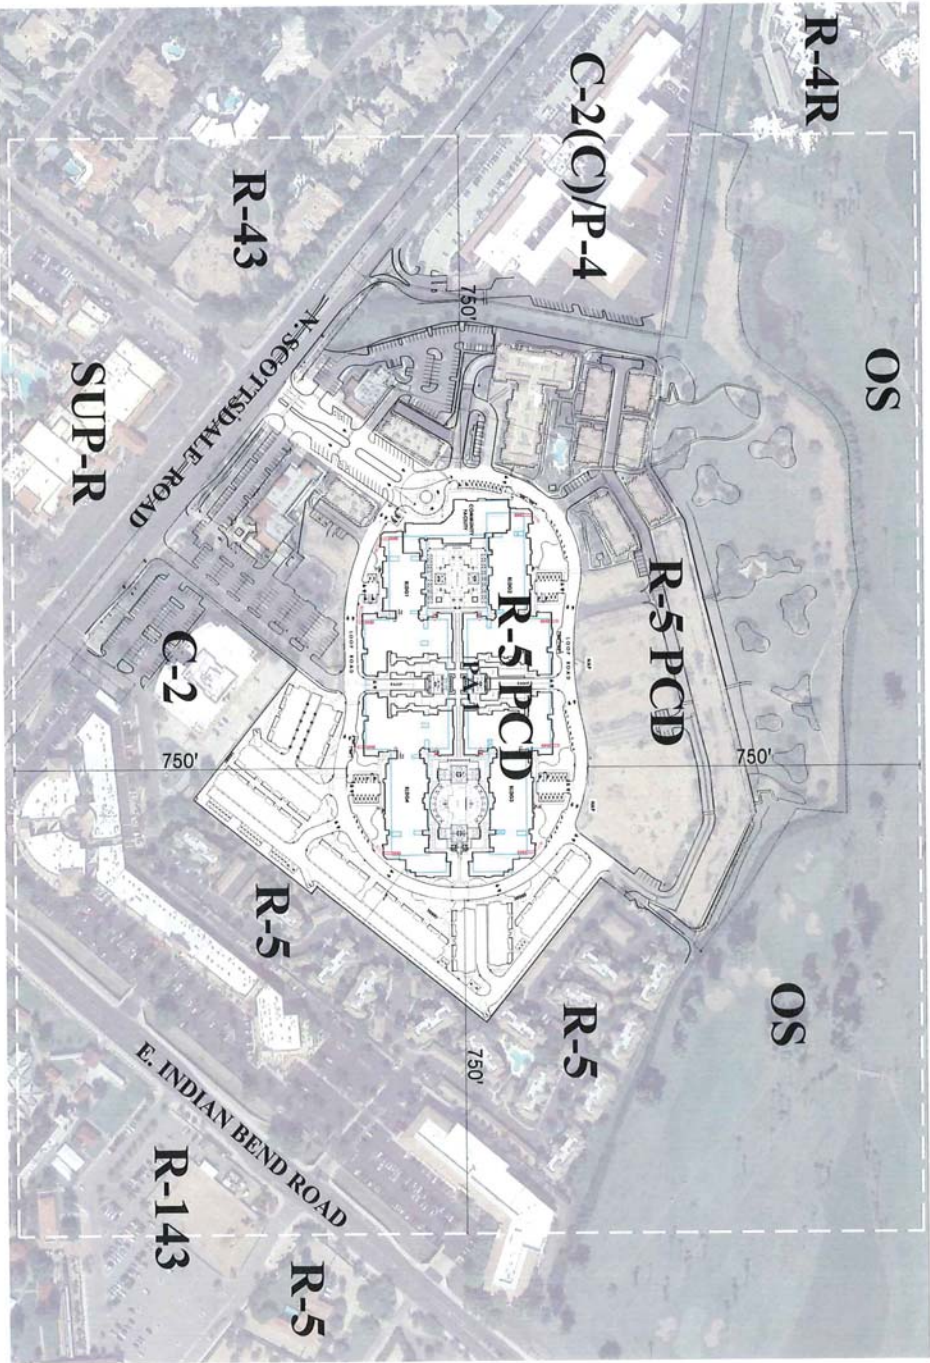

SCALE: 1" = 100.00'

PA-1
CONTEXT AERIAL

PROJECT ADDRESS:
1711 N. SCOTTSDALE ROAD
SCOTTSDALE, ARIZONA
DMS SUBMITTAL: DR-2017

16-DR-2017
7/13/17

ARCHITECT
BUCILLA GROUP ARCHITECTURE
1600 West Camelback Road, Suite 100
Phoenix, AZ 85015
Tel: 602.998.8888
Fax: 602.998.8889
www.bucillagroup.com



Project:
ARTESIA DRUG CENTER
27th N. SCOTTSDALE ROAD
SCOTTSDALE, ARIZONA

Owner:
ARTESIA DRUG CENTER
27th N. SCOTTSDALE ROAD
SCOTTSDALE, ARIZONA

1/2 DATE DESCRIPTION
DATE DESCRIPTION


NO.	DATE	DESCRIPTION

Project Number:
BCA No. 15029

Sheet Title:
PA1 / PM13
CONTEXT AERIAL PLAN

Sheet No.:
SP-20

0 - 1/2" = 1" (AS SHOWN)

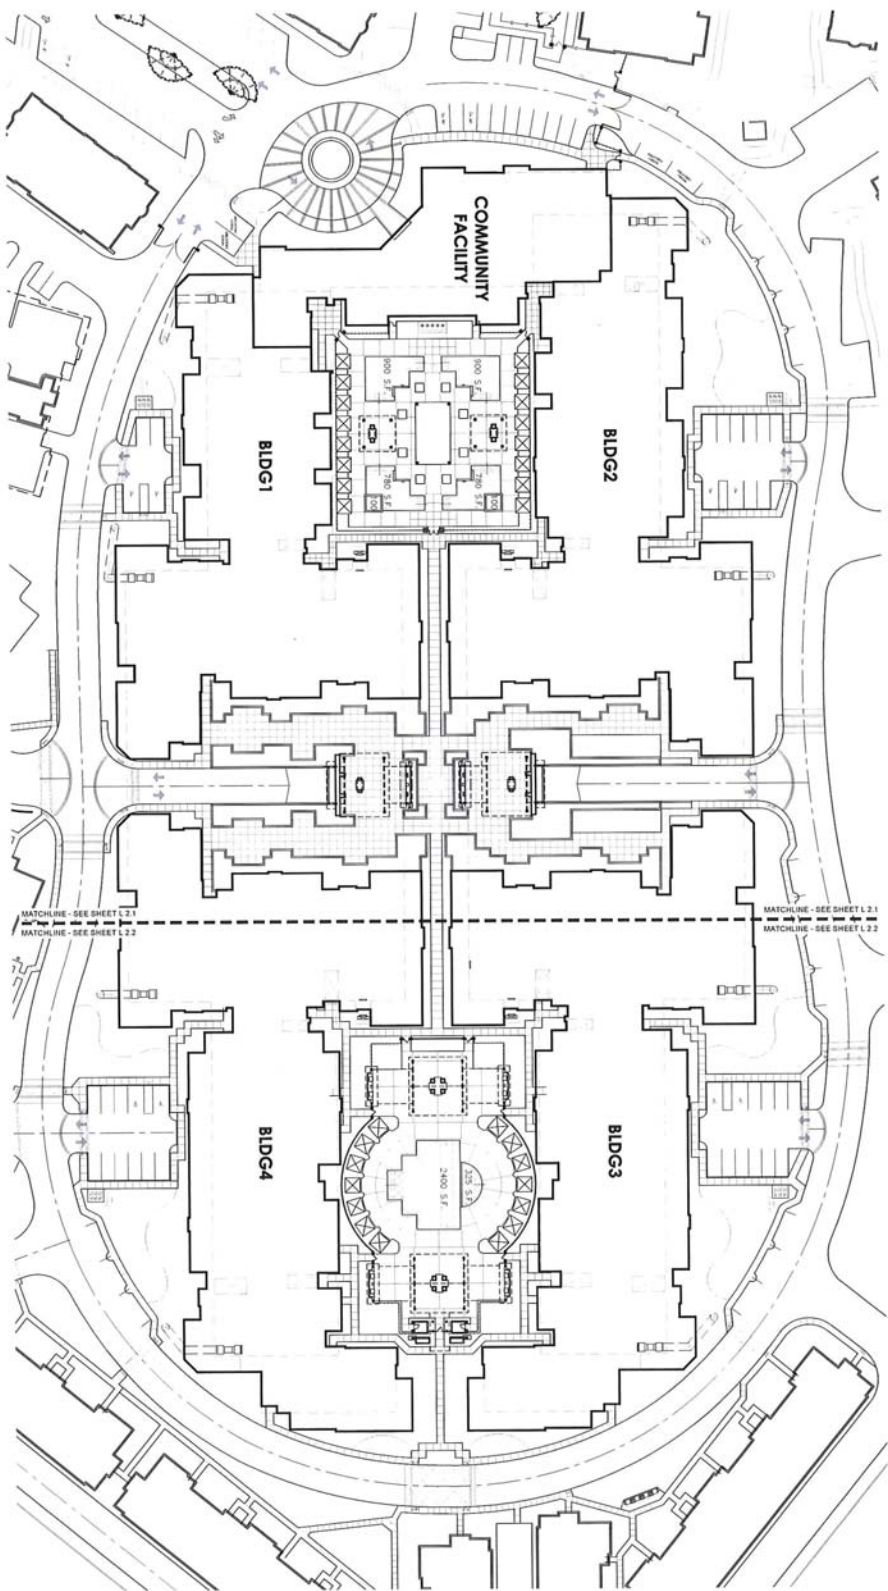

BGA Budella Group Architecture

Budella Group Architecture
 19782 MacArthur Blvd., Suite 270
 Phoenix, AZ 85024
 Phone: 480.951.6580
 www.bg-architecture.com

Antesia

Hardscape Plan - Overall


16-DR-2017
 7/13/17

Scottsdale Road & Indian Bend Road
 Scottsdale, AZ
 July 13, 2017
 Scale: 1" = 30'-0" @ 24"x36"

L.2.0

OTAK landscape architecture
 urban design
 51 West Third Street, Suite 201
 Phoenix, AZ 85003
 Phone: 602.258.8822
 www.otak.com

16-DR-2017
 7/13/17

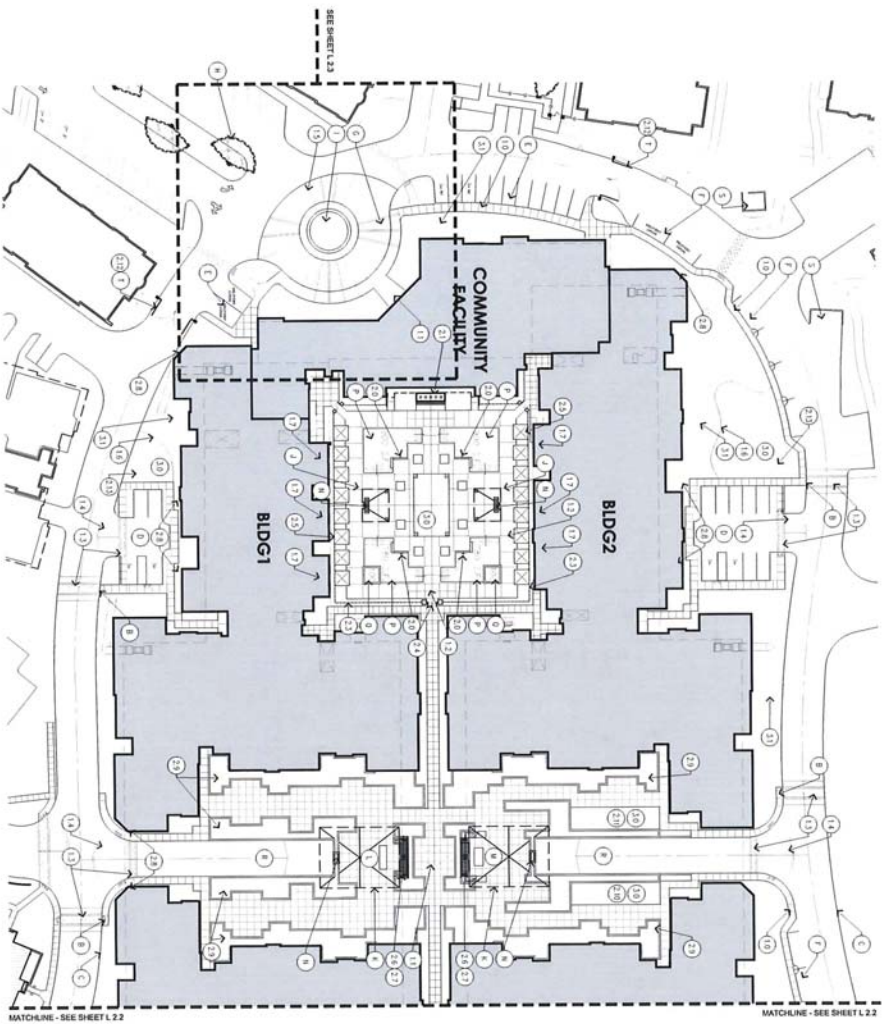

HARDSCAPE KEYNOTES

KEY	DESCRIPTION
1	SPRING CONDITIONS / TOPGRAPHIC SURVEILLANCE
2	CONCRETE
3	CONCRETE
4	CONCRETE
5	CONCRETE
6	CONCRETE
7	CONCRETE
8	CONCRETE
9	CONCRETE
10	CONCRETE
11	CONCRETE
12	CONCRETE
13	CONCRETE
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93	CONCRETE
94	CONCRETE
95	CONCRETE
96	CONCRETE
97	CONCRETE
98	CONCRETE
99	CONCRETE
100	CONCRETE

BCA Buccia Group Architecture
 Buccia Group Architecture
 18782 MacArthur Blvd., Suite 270
 Irvine, CA 92618
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 www.bg-architecture.com

Antesia


Hardscape Plan - North End

Scottsdale Road & Indian Bend Road
 Scottsdale, AZ July 03, 2017
 Scale: 1" = 30'-0" @ 24"x36"

L 2.1

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16-DR-2017
 7/13/17

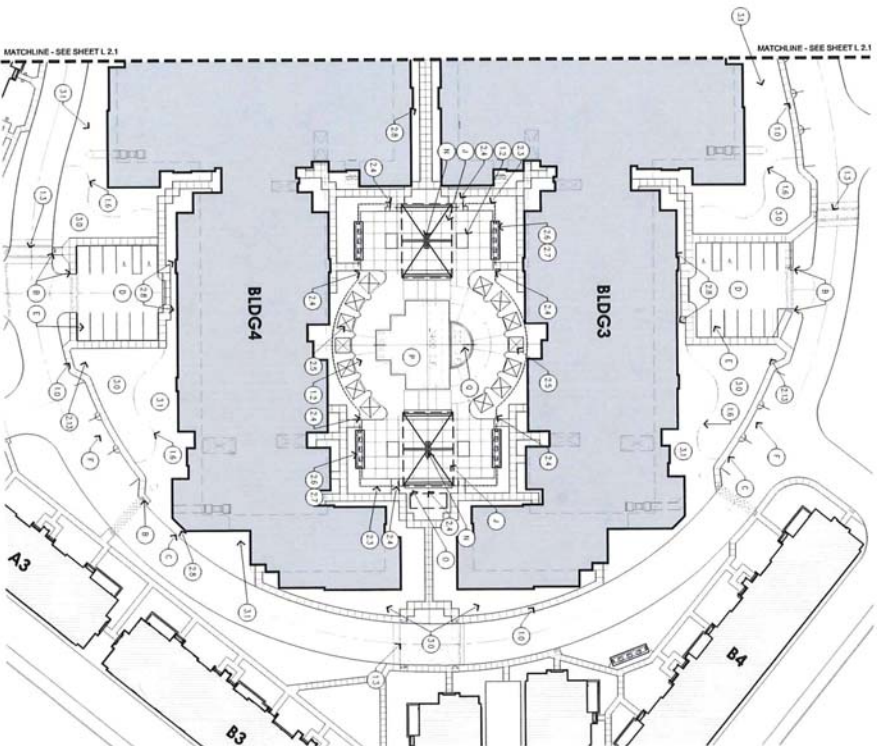

Antesia

Hardscape Plan - South End

Scottsdale Road & Indian Bend Road
Scottsdale, AZ July 18, 2017



L.2.2

16-DR-2017
7/13/17

BGA Budella Group Architecture
Budella Group Architecture
19782 MacArthur Blvd., Suite 270
Phoenix, AZ 85028
Phone: 480.951.0550
www.bg-architecture.com

HARDSCAPE KEYNOTES

1) EXISTING CONDITIONS / USGS/NA REFERENCE

NO.	SYMBOL	DESCRIPTION
1	(Symbol)	EXISTING CONCRETE
2	(Symbol)	EXISTING ASPHALT
3	(Symbol)	EXISTING GRAVEL
4	(Symbol)	EXISTING SAND
5	(Symbol)	EXISTING SOIL
6	(Symbol)	EXISTING CURB
7	(Symbol)	EXISTING DRIVEWAY
8	(Symbol)	EXISTING SIDEWALK
9	(Symbol)	EXISTING BIKEWAY
10	(Symbol)	EXISTING PLANTING
11	(Symbol)	EXISTING LIGHT FIXTURE
12	(Symbol)	EXISTING SIGNAGE
13	(Symbol)	EXISTING FENCE
14	(Symbol)	EXISTING WALL
15	(Symbol)	EXISTING DOOR
16	(Symbol)	EXISTING WINDOW
17	(Symbol)	EXISTING ROOF
18	(Symbol)	EXISTING FOUNDATION
19	(Symbol)	EXISTING UTILITY
20	(Symbol)	EXISTING EROSION CONTROL
21	(Symbol)	EXISTING DRAINAGE
22	(Symbol)	EXISTING LANDSCAPE LIGHTING
23	(Symbol)	EXISTING LANDSCAPE IRRIGATION
24	(Symbol)	EXISTING LANDSCAPE FURNITURE
25	(Symbol)	EXISTING LANDSCAPE MATERIALS
26	(Symbol)	EXISTING LANDSCAPE PLANTINGS
27	(Symbol)	EXISTING LANDSCAPE TREES
28	(Symbol)	EXISTING LANDSCAPE SHRUBS
29	(Symbol)	EXISTING LANDSCAPE PERENNIALS
30	(Symbol)	EXISTING LANDSCAPE ANNUALS
31	(Symbol)	EXISTING LANDSCAPE GRASSES
32	(Symbol)	EXISTING LANDSCAPE MOSS
33	(Symbol)	EXISTING LANDSCAPE LICHENS
34	(Symbol)	EXISTING LANDSCAPE FUNGI
35	(Symbol)	EXISTING LANDSCAPE BIRDS
36	(Symbol)	EXISTING LANDSCAPE INSECTS
37	(Symbol)	EXISTING LANDSCAPE AMPHIBIANS
38	(Symbol)	EXISTING LANDSCAPE REPTILES
39	(Symbol)	EXISTING LANDSCAPE MAMMALS
40	(Symbol)	EXISTING LANDSCAPE VEGETATION
41	(Symbol)	EXISTING LANDSCAPE WILDLIFE
42	(Symbol)	EXISTING LANDSCAPE HABITAT
43	(Symbol)	EXISTING LANDSCAPE CORRIDORS
44	(Symbol)	EXISTING LANDSCAPE BARRIERS
45	(Symbol)	EXISTING LANDSCAPE CONNECTORS
46	(Symbol)	EXISTING LANDSCAPE NODES
47	(Symbol)	EXISTING LANDSCAPE LINKS
48	(Symbol)	EXISTING LANDSCAPE SPINES
49	(Symbol)	EXISTING LANDSCAPE CLUSTERS
50	(Symbol)	EXISTING LANDSCAPE NETWORKS

2) MATERIAL FINISHES


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3	(Symbol)	GRAVEL
4	(Symbol)	SAND
5	(Symbol)	SOIL
6	(Symbol)	CURB
7	(Symbol)	DRIVEWAY
8	(Symbol)	SIDEWALK
9	(Symbol)	BIKEWAY
10	(Symbol)	PLANTING
11	(Symbol)	LIGHT FIXTURE
12	(Symbol)	SIGNAGE
13	(Symbol)	FENCE
14	(Symbol)	WALL
15	(Symbol)	DOOR
16	(Symbol)	WINDOW
17	(Symbol)	ROOF
18	(Symbol)	FOUNDATION
19	(Symbol)	UTILITY
20	(Symbol)	EROSION CONTROL
21	(Symbol)	DRAINAGE
22	(Symbol)	LANDSCAPE LIGHTING
23	(Symbol)	LANDSCAPE IRRIGATION
24	(Symbol)	LANDSCAPE FURNITURE
25	(Symbol)	LANDSCAPE MATERIALS
26	(Symbol)	LANDSCAPE PLANTINGS
27	(Symbol)	LANDSCAPE TREES
28	(Symbol)	LANDSCAPE SHRUBS
29	(Symbol)	LANDSCAPE PERENNIALS
30	(Symbol)	LANDSCAPE ANNUALS
31	(Symbol)	LANDSCAPE GRASSES
32	(Symbol)	LANDSCAPE MOSS
33	(Symbol)	LANDSCAPE LICHENS
34	(Symbol)	LANDSCAPE FUNGI
35	(Symbol)	LANDSCAPE BIRDS
36	(Symbol)	LANDSCAPE INSECTS
37	(Symbol)	LANDSCAPE AMPHIBIANS
38	(Symbol)	LANDSCAPE REPTILES
39	(Symbol)	LANDSCAPE MAMMALS
40	(Symbol)	LANDSCAPE VEGETATION
41	(Symbol)	LANDSCAPE WILDLIFE
42	(Symbol)	LANDSCAPE HABITAT
43	(Symbol)	LANDSCAPE CORRIDORS
44	(Symbol)	LANDSCAPE BARRIERS
45	(Symbol)	LANDSCAPE CONNECTORS
46	(Symbol)	LANDSCAPE NODES
47	(Symbol)	LANDSCAPE LINKS
48	(Symbol)	LANDSCAPE SPINES
49	(Symbol)	LANDSCAPE CLUSTERS
50	(Symbol)	LANDSCAPE NETWORKS

3) NEAR LANDSCAPE MATERIALS

NO.	SYMBOL	DESCRIPTION
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3	(Symbol)	GRAVEL
4	(Symbol)	SAND
5	(Symbol)	SOIL
6	(Symbol)	CURB
7	(Symbol)	DRIVEWAY
8	(Symbol)	SIDEWALK
9	(Symbol)	BIKEWAY
10	(Symbol)	PLANTING
11	(Symbol)	LIGHT FIXTURE
12	(Symbol)	SIGNAGE
13	(Symbol)	FENCE
14	(Symbol)	WALL
15	(Symbol)	DOOR
16	(Symbol)	WINDOW
17	(Symbol)	ROOF
18	(Symbol)	FOUNDATION
19	(Symbol)	UTILITY
20	(Symbol)	EROSION CONTROL
21	(Symbol)	DRAINAGE
22	(Symbol)	LANDSCAPE LIGHTING
23	(Symbol)	LANDSCAPE IRRIGATION
24	(Symbol)	LANDSCAPE FURNITURE
25	(Symbol)	LANDSCAPE MATERIALS
26	(Symbol)	LANDSCAPE PLANTINGS
27	(Symbol)	LANDSCAPE TREES
28	(Symbol)	LANDSCAPE SHRUBS
29	(Symbol)	LANDSCAPE PERENNIALS
30	(Symbol)	LANDSCAPE ANNUALS
31	(Symbol)	LANDSCAPE GRASSES
32	(Symbol)	LANDSCAPE MOSS
33	(Symbol)	LANDSCAPE LICHENS
34	(Symbol)	LANDSCAPE FUNGI
35	(Symbol)	LANDSCAPE BIRDS
36	(Symbol)	LANDSCAPE INSECTS
37	(Symbol)	LANDSCAPE AMPHIBIANS
38	(Symbol)	LANDSCAPE REPTILES
39	(Symbol)	LANDSCAPE MAMMALS
40	(Symbol)	LANDSCAPE VEGETATION
41	(Symbol)	LANDSCAPE WILDLIFE
42	(Symbol)	LANDSCAPE HABITAT
43	(Symbol)	LANDSCAPE CORRIDORS
44	(Symbol)	LANDSCAPE BARRIERS
45	(Symbol)	LANDSCAPE CONNECTORS
46	(Symbol)	LANDSCAPE NODES
47	(Symbol)	LANDSCAPE LINKS
48	(Symbol)	LANDSCAPE SPINES
49	(Symbol)	LANDSCAPE CLUSTERS
50	(Symbol)	LANDSCAPE NETWORKS

OTAK landscape architecture
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Phone: 602.258.8823
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16-DR-2017
7/13/17

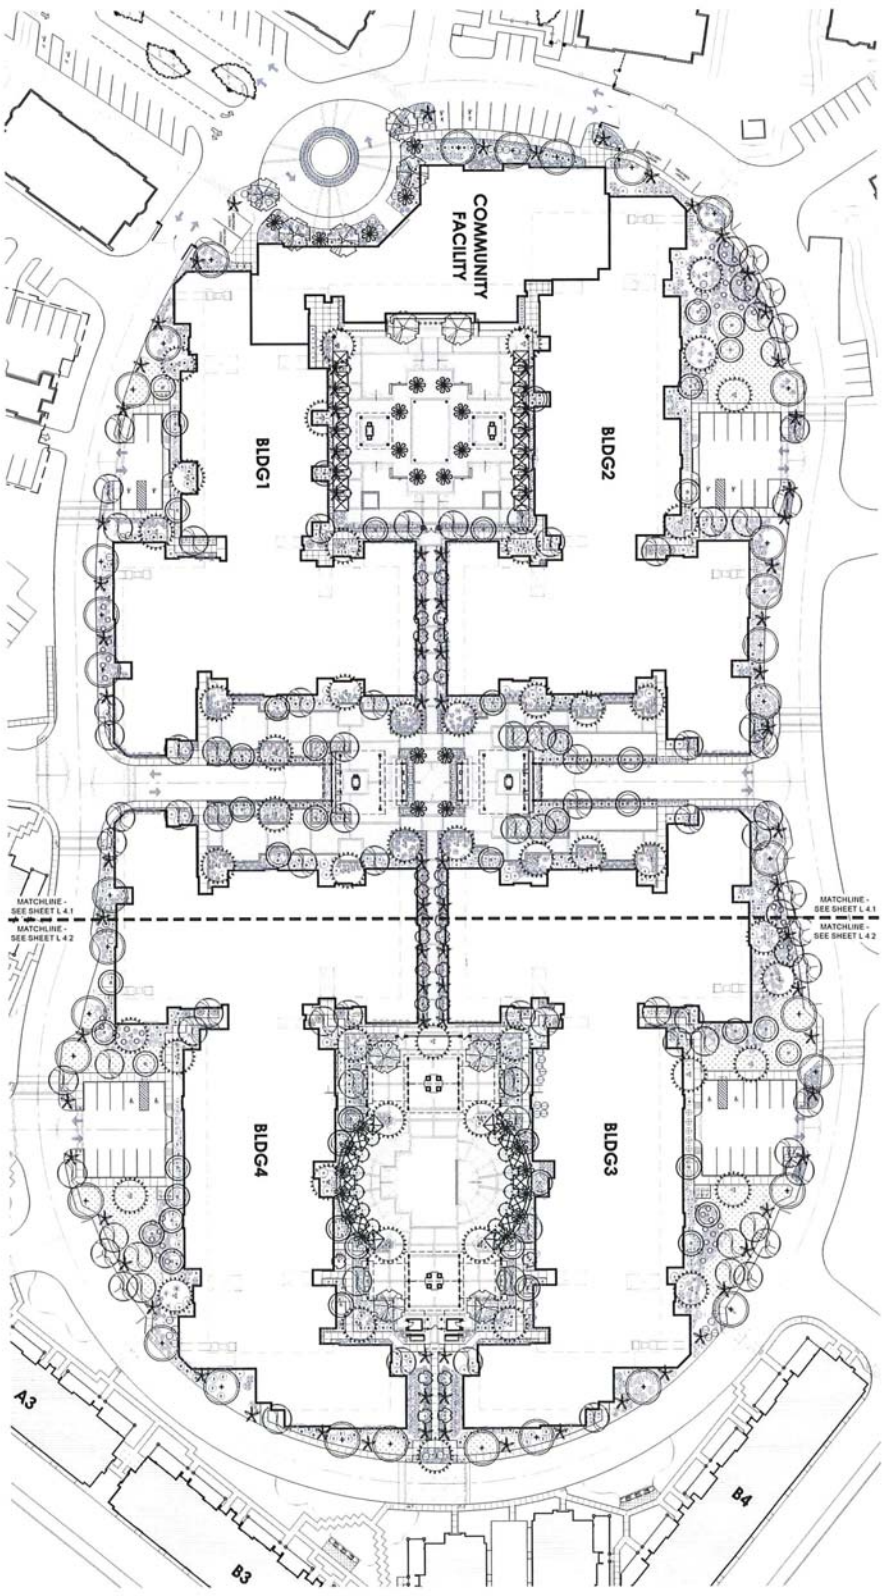

Antesia

Landscape Plan - Overall

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Scholarship Road & Indian Bend Road
 Section
 0 25 50 75 100 150
 Scale: 1" = 30'-0" @ 24"x36"

L 4.0




OTAK landscape architecture
 urban design

31 West Park Street, Suite 201
 Raleigh, NC 27603
 Phone: 919.833.0100
 www.otak.com

16-DR-2017
 7/13/17

BGA Bacilia Group Architecture

Bacilia Group Architecture
 19782 Mass Avenue, Suite 200
 Raleigh, NC 27617
 Phone: 919.851-9080
 www.bg-architecture.com

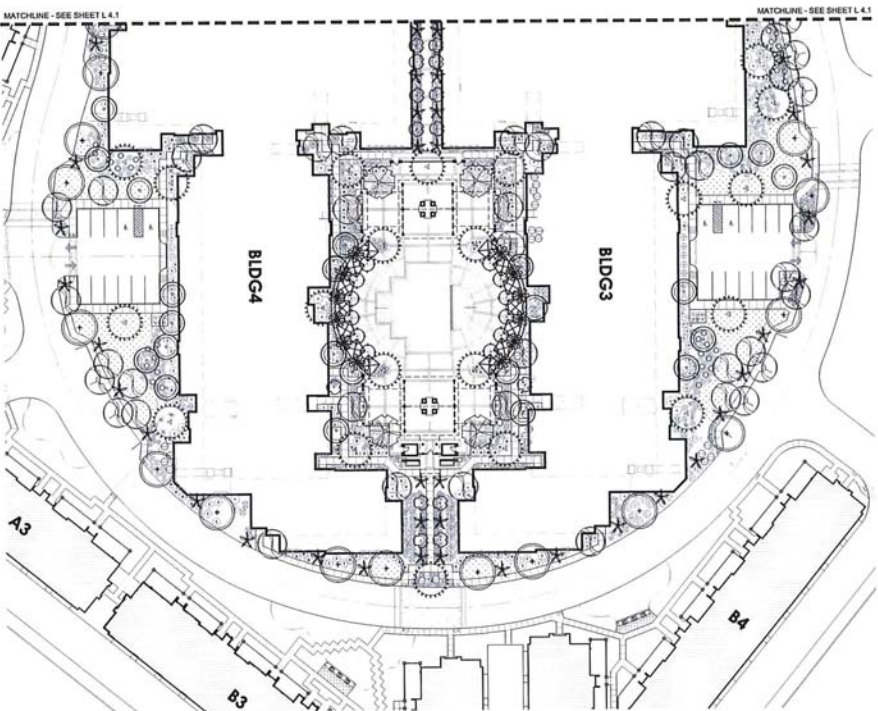

PLANTING LEGEND

SYMBOL	DESCRIPTION	QUANTITY	SIZE	NOTES
○	Planting	120	12"	
○	Planting	120	18"	
○	Planting	120	24"	
○	Planting	120	36"	
○	Planting	120	48"	
○	Planting	120	852"	
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○	Planting	120	876"	
○	Planting	120	888"	
○	Planting	120	900"	
○	Planting	120	912"	
○	Planting	120	924"	
○	Planting	120	936"	
○	Planting	120	948"	
○	Planting	120	960"	
○	Planting	120	972"	
○	Planting	120	984"	
○	Planting	120	996"	
○	Planting	120	1008"	

BGA Buccia Group Architecture

Buccia Group Architecture
19792 MacArthur Blvd., Suite 270
Irvine, CA 92618
Phone: 949.261.8800
www.bg-architecture.com

Artesia

Landscape Plan - South End

Scottsdale Road & Indian Bend Road
Scottsdale, AZ July 19, 2017
Scale: 1" = 30'-0" @ 24"x36"

L 4.2

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urban design
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16-DR-2017
7/13/17



Pinus Chatterbox



Bauhinia compacta



Cercidium 'Desert Museum'



Lycium microphyllum 'Bombini'



Chrysa tesota



Potexis dahyifera




Quercus virginiana



Sapota secundiflora



Washingtonia robusta

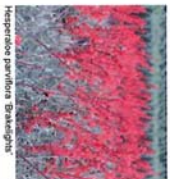

Hesperis matronalis 'Bawleigh'



Cassia grandiflora



Hibiscus rosa-sinensis



Myrica communis



Veronica stricta



Bougainvillea Barbara Kent



Chamaerops humilis



Justicia spicigera



Phoenix roebelenii



Matisia sinensis



Ceanothus pulcherrimus




Euphorbia rigida



Lantana camara 'Gold Mouse'



Roumex crispus

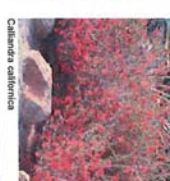

Calliandra californica



Ficus setosissima



Leucophyllum frutescens 'Green Cloud'



Ruellia peninsularis



Callisotum venulosum



Hardenbergia violacea



Muhlenbergia rigens



Tecoma stans



Desert Gold Decomposed Granite



Pioneer Dunny Artificial Turf

Shade Trees & Palm Trees

Shrubs, Vines, Accents, and Groundcovers

Inset Landscape Materials

BGA Buccella Group Architecture

Buccella Group Architecture
19782 MacArthur Blvd., Suite 270
Phoenix, AZ 85024
Phone: 949.851.9080
www.bg-architecture.com

Aestesia


Landscape Material & Imagery

Scottsdale Road & Indian Bend Road
Scottsdale, AZ | July - 13, 2017

L 4.3

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urban design
31 West Third Street, Suite 201
Phoenix, AZ 85003
Phone: 602.252.8873
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16-DR-2017
7/13/17

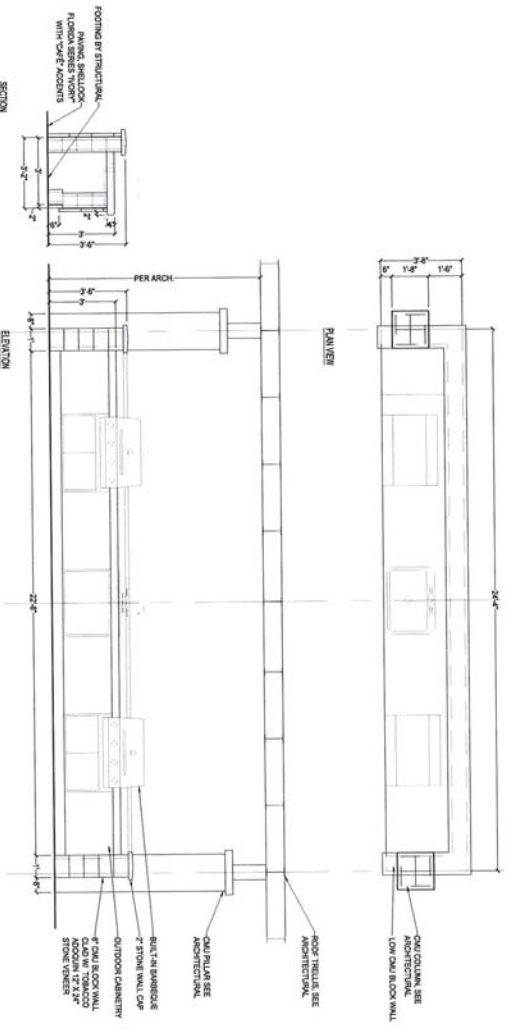


Material used at pool gate and fence posts, frames, and mesh panels. See details 6 & 7 on sheet L5.1 of this set.



Material used at trellis structure. See detail 2 on sheet L5.0 of this set.


1 BARBECUE TRELLIS

SCALE 1/2"=1'-0"

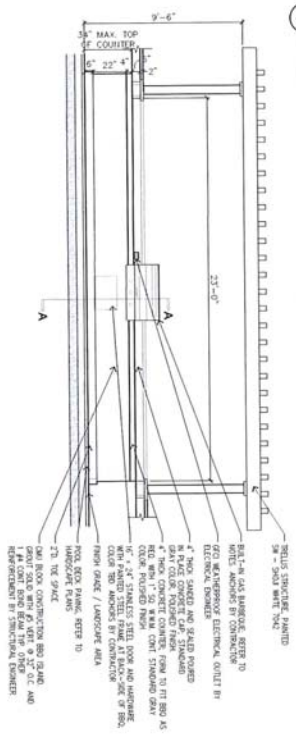

2 TRIPLE BBQ AT KITCHEN AREA RAMADAS

SCALE 1/8"=1'-0"

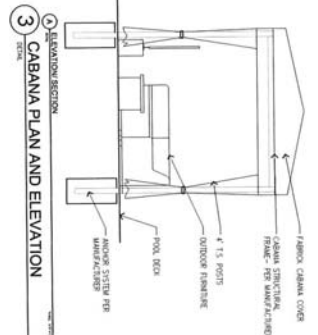

3 CABANA PLAN AND ELEVATION

SCALE 3/8"=1'-0"

BCA Buccella Group Architecture
 19762 MacArthur Blvd., Suite 270
 Irvine, CA 92612
 Phone: 949.453.8800
 www.bg-architecture.com

Artesia

Design Details, Colors, & Materials

Scottsdale Road & Indian Bend Road
 Scottsdale, AZ July 13, 2017

L5.0


otak landscape architecture
 urban design
 51 West King Street, Suite 201
 Irvine, CA 92612
 Phone: 949.453.8800
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16-DR-2017
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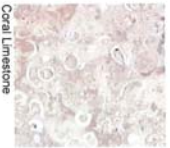
4 LOW WALL
SCALE: 1/2\"/>

SCALE: 1/2\"/>




6 TYPICAL POOL FENCE
SCALE: 1/2\"/>

SCALE: 1/2\"/>

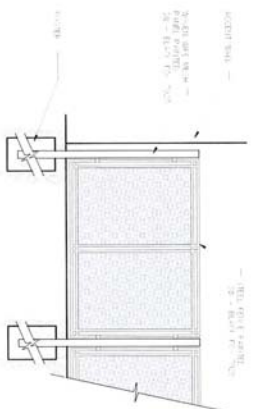


Coral Limestone

Material used in low stone and raised planter walls. See details 4 & 5 on sheet L5.1 of this set.

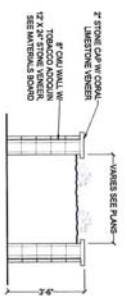

5 RAISED PLANTER WALLS
SCALE: 1/2\"/>

SCALE: 1/2\"/>

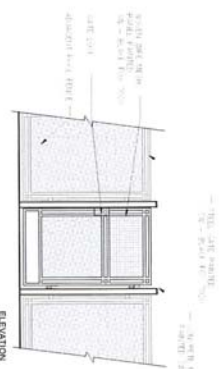

7 POOL ENTRY GATE / SECURITY FENCE (TYP.)
SCALE: 1/2\"/>

SCALE: 1/2\"/>



Tobacco Adoqueun

Material used in BBQ walls, low stone walls, and raised planter walls. See detail 1 on sheet L5.0 and details 4, and 5 on sheet L5.1 of this set.

BGA Buclla Group Architecture

Bucilla Group Architecture
19742 MacArthur Blvd., Suite 210
Houston, TX 77058
Phone: 281-561-1888
www.bg-architecture.com

Artesia

Design Details, Colors, & Materials

Seaside Road & Indian Bend Road
Schlossdale, AZ July -15, 2017

L 5.1

Otak landscape architecture
urban design
51 West Third Street, Suite 201
Phoenix, AZ 85003
Phone: 602-258-2222
www.otak.com

16-DR-2017
7/13/17




Shellock Paver - Atlantic Ivory color



Shellock Paver - Atlantic Cafe color

Shellock Paver material used at pool deck. See detail 10 on sheet L5.2 of this set.


Detailed image and overview perspective images are for reference and visualization only of paver application. Please refer to detail 10 on sheet L5.2 of this sheet.

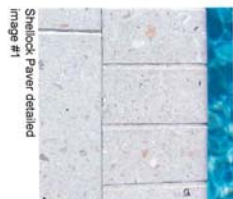

Shellock Paver detailed image #1




Shellock Paver overview perspective image #2

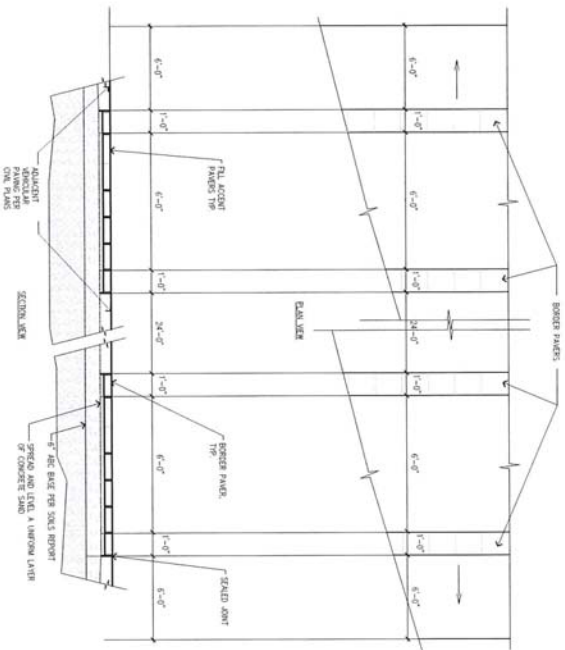


8 PEDESTRIAN CROSSWALKS

SCALE: NTS

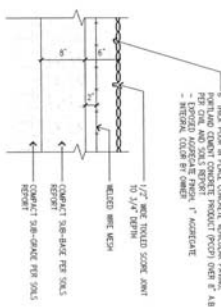


9 VEHICULAR ACCENT PAVING

SCALE: NTS

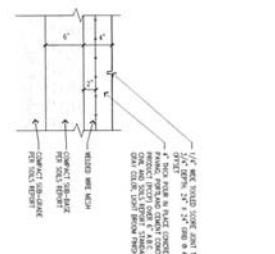


11 PEDESTRIAN ACCENT PAVING

SCALE: NTS

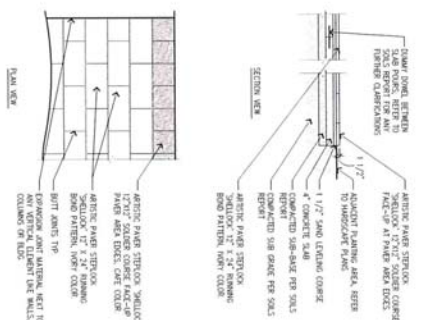

10 POOL ACCENT PAVERS

SCALE: NTS

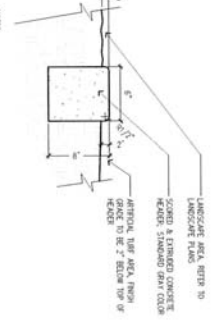

12 CONCRETE HEADER

SCALE: NTS

BGA
Bucilla Group Architecture
19782 MacArthur Blvd, Suite 270
Phoenix, AZ 85024
Phone: 480.881-1980
www.bg-architecture.com

Antesia

Design Details, Colors, & Materials

Scottsdale Road & Indian Bend Road
Scottsdale, AZ | July 13, 2017


L 5.2

otak landscape architecture
51 Third Street, Suite 201
Phoenix, AZ 85001
Phone: 480.881-1980
www.otak.com

16-DR-2017
7/13/17

13 BOCCO COURT AT ARTIFICIAL TURF


SCALE: 1/8" = 1'-0"

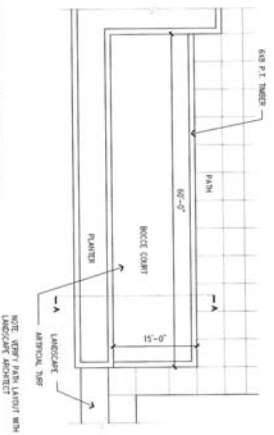


NOTE: REFER PLAN LAYOUT WITH LANDSCAPE ARCHITECT

14 TABLE GAMES AT ARTIFICIAL TURF

SCALE: 1/8" = 1'-0"

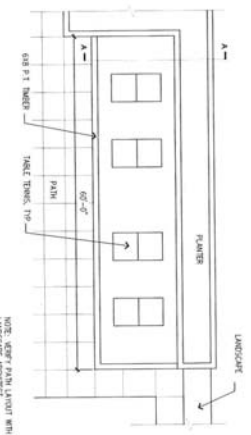


NOTE: REFER PLAN LAYOUT WITH LANDSCAPE ARCHITECT

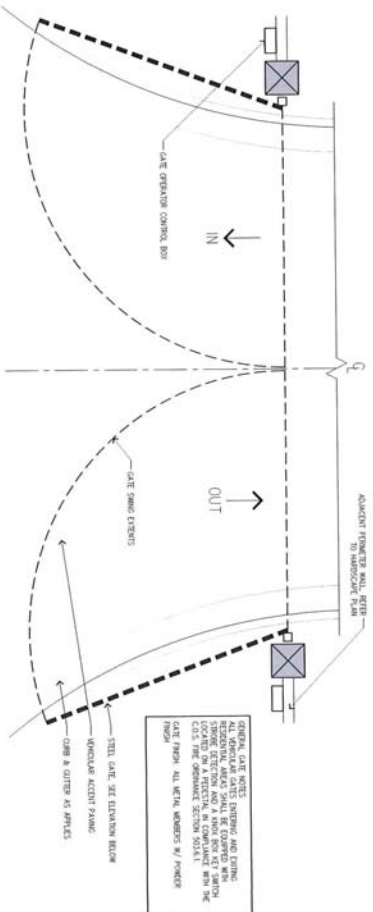

15 VEHICULAR GATE

SCALE: 1/8" = 1'-0"

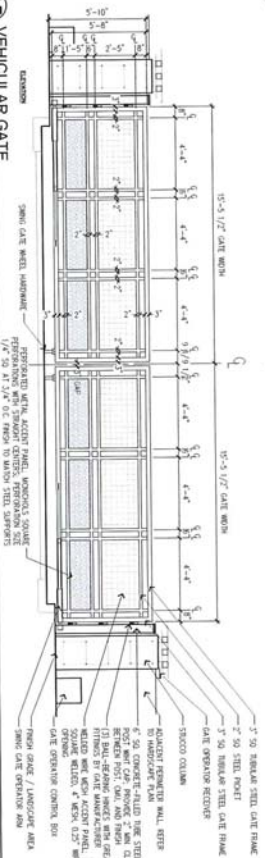

BCA Buell Group Architecture

Buell Group Architecture
19762 MacArthur Blvd., Suite 270
Irvine, CA 92612
Phone: 949-851-9680
www.bg-architecture.com

Artesia



Design Details, Colors, & Materials

Scottsdale Road & Indian Bend Road
Scottsdale, AZ | July 13, 2017


L 5.3

otak landscape architecture
urban design
51 West King Street, Suite 201
Irvine, CA 92612
Phone: 949-453-8877

16-DR-2017
7/13/17

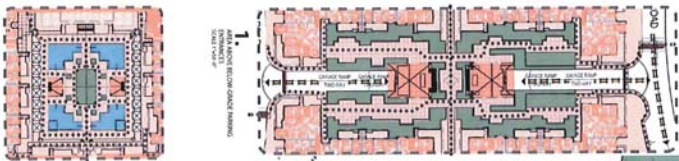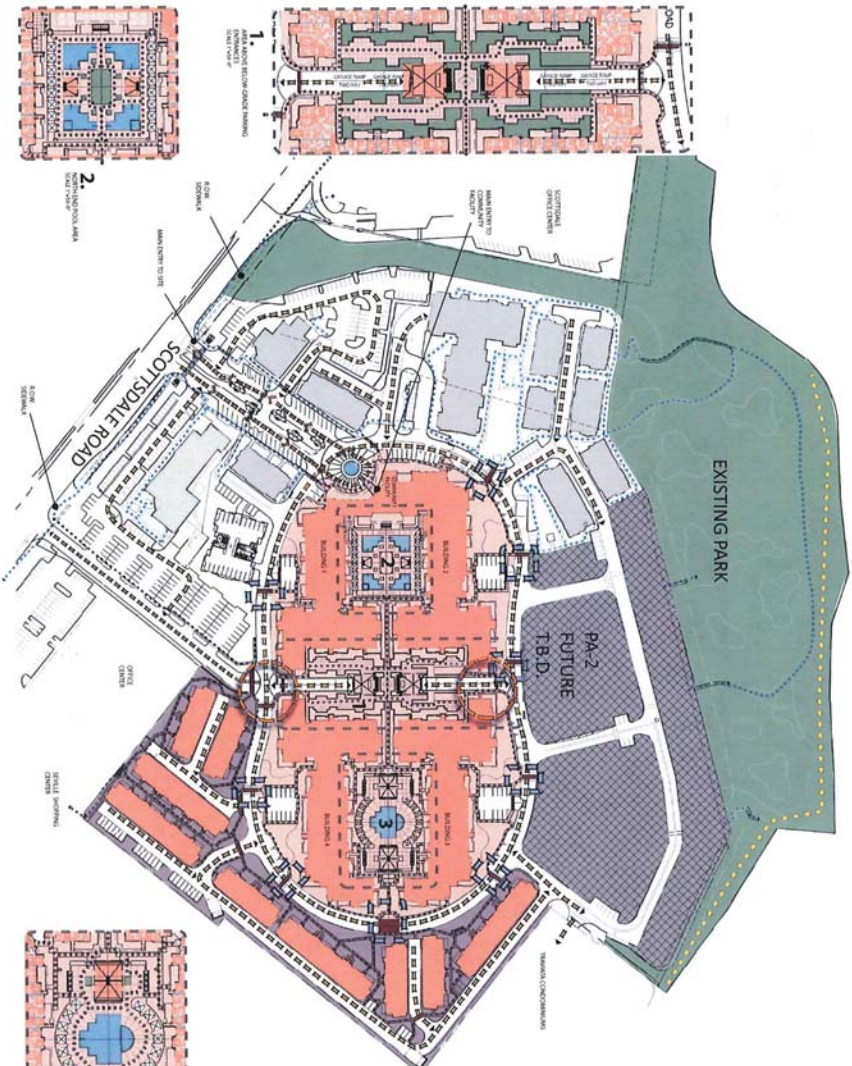

1
SCOTT SOALE ROAD
TRAIL CENTER

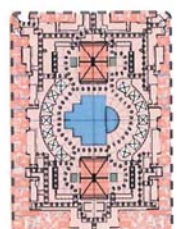

2
SCOTT SOALE ROAD
TRAIL CENTER



3
SCOTT SOALE ROAD
TRAIL CENTER

- LEGEND**
- PARKING GARAGE INTERSECTIONS
 - PEDESTRIAN CROSSWALKS
 - INTERIOR ROADS
 - PROPOSED SIDEWALKS
 - EXISTING SIDEWALKS
 - PROPOSED TRAIL EASEMENT
 - PROPOSED CROSSWALKS
 - AREA PA-1
 - AREA PA-2
 - AREA PA-3
 - PROPOSED BUILDING
 - EXISTING BUILDING
 - EXISTING PARK AND WASH
- NORTH

BCA Buccella Group Architecture
 Buccella Group Architecture
 19782 MacArthur Blvd, Suite 270
 Phoenix, AZ 85027
 Phone: 480.951.7000
 www.bg-architecture.com

Antesia


Pedestrian Circulation Plan

Scottsdale Road & Indian Bend Road
 Scottsdale, AZ July 26, 2017
 Scale: 1" = 80'-0" @ 24"x36"

L 8.0

OTAK landscape architecture
 urban design
 51 West Third Street, Suite 201
 Phoenix, AZ 85003
 Phone: 602.277.8870
 www.otak.com

16-DR-2017
 7/13/17

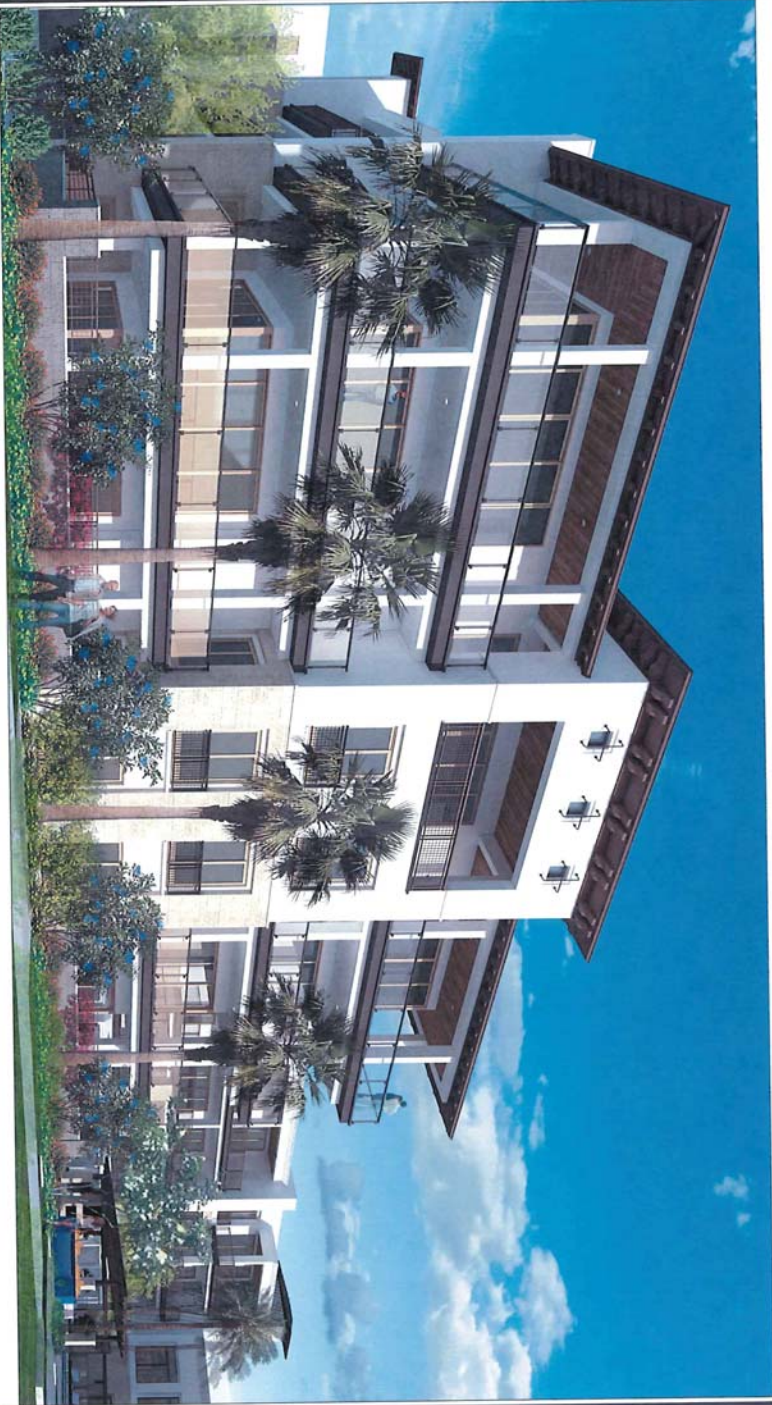

PA-1
RESIDENTIAL
BUILDING ILLUSTRATION - 3

PROJECT ADDRESS:
7171 N. SCOTTSDALE ROAD
SCOTTSDALE, ARIZONA
DBB SUBMITTAL: 16-DR-17

16-DR-2017
7/13/17

ARCHITECT
BUCILLA
G ROUP
ARCHITECTURE
Architectural, Planning, Interiors
1000 N. CENTRAL EXPRESSWAY
SUITE 1000 PHOENIX, AZ 85004
PH: 602.955.1100 FAX: 602.955.1101
WWW.BUCILLAGROUP.COM



Project:
ARTESA
RESIDENTIAL
SCOTTSDALE, ARIZONA

Owner:
ARTESA DEVELOPMENT
100 N. CENTRAL
SCOTTSDALE, ARIZONA

NO.	DATE	DESCRIPTION
1	07/13/17	PRELIMINARY
2	07/13/17	REVISED
3	07/13/17	REVISED
4	07/13/17	REVISED
5	07/13/17	REVISED
6	07/13/17	REVISED
7	07/13/17	REVISED
8	07/13/17	REVISED
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99	07/13/17	REVISED
100	07/13/17	REVISED

Project Number:
BCA No. 15029
Sheet Title:
PA-1 - RESIDENTIAL
BUILDING
ILLUSTRATIONS
Sheet No:
IMG-3

Q - 10/13/17



PA-1
RESIDENTIAL
BUILDING ILLUSTRATION - 4

PROJECT ADDRESS:
7171 N. SCOTTSDALE ROAD
SCOTTSDALE, ARIZONA
DRWG SUBMITTAL: 06-09-17

16-DR-2017
7/13/17

ARCHITECT:
BUONILLA
GROUP
ARCHITECTURE
Architectural, Planning, Engineering
10000 North Central Expressway
Suite 1000 Phoenix, AZ 85020
Tel: 602.998.8888 Fax: 602.998.0100
www.buonillagroup.com



PROJECT: 16-DR-2017-0001
Prepared:
ARTESIA
ARCHITECTURAL GROUP
SCOTTSDALE, ARIZONA


Checked:
ARTESIA DEVELOPMENT
SCOTTSDALE, ARIZONA
NO DATE DESCRIPTION
REVISION
BY APPROVED
DATE

Project Number:
BCA No. 15029

Project Title:
PA1 - RESIDENTIAL
BUILDING
ILLUSTRATION-4

Sheet No.:
IMC-4

0 - 1/4" = 1'-0" (AS SHOWN)

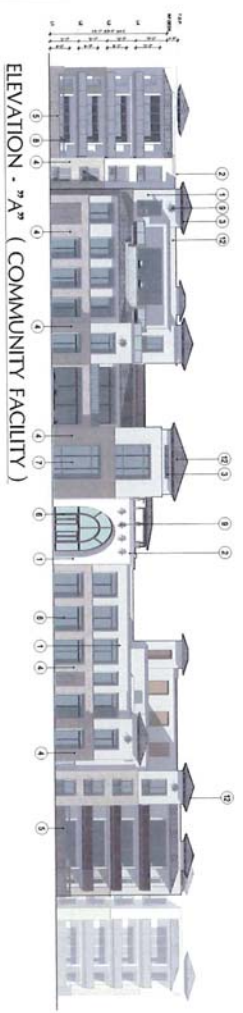


ELEVATION - "A" (COMMUNITY FACILITY)



ELEVATION - "B" (COMMUNITY FACILITY/BLDC 1)



ELEVATION - "C1" (BLDG 1)

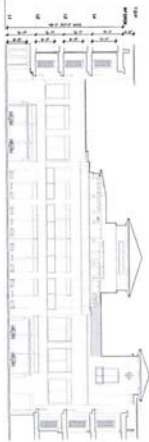


ELEVATION - "C2" (COMMUNITY FACILITY)



ELEVATION - "D" (BLDG 1)

1	Building - Wall Building - Veranda Edge Building - Wall Niche	
2	Facade Founn - Residential Veranda Facade Founn - Community Facility Entry	
3	Dbl Corbels with trim board behind Balustr Tail	
4	Stone - Building Wall Stone - Building Wall	
5	Stone - Garden Walls with stone cap Stone - Portc Cochere with stone cap	
6	Window / Door - Residential Units Window / Door - Community Facility	
7	Glazing - Door and Window	
8	Railing	
9	Porte Cochere Accent Ornile	
10	Building Lighting	
11	Roof - Flat	
12	Roof - Flat Tile	

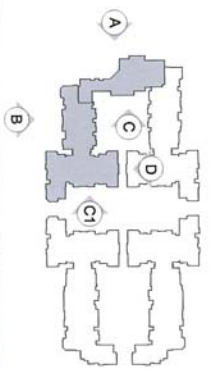

PROJECT: **BLUCILLA GROUP ARCHITECTURE**
 16-DR-2017
 7/13/17
 A-110

OWNER: **ARTISIA MICHIGAN SCOTTISH-IRISH MICHIGAN MID-RISE RESIDENTIAL BUILDING PHASE 1**

DESIGNER: **ARTISIA DEVELOPMENT PARTNERS LLC**

DATE: 7/13/17

SCALE: 1/8" = 1'-0"

PROJECT NO: 16-DR-2017


DATE: 7/13/17

BY: [Signature]

FOR: [Signature]

BLDC No. 1529 (P-4)

BLDC ELEVATIONS COMMUNITY FACILITY

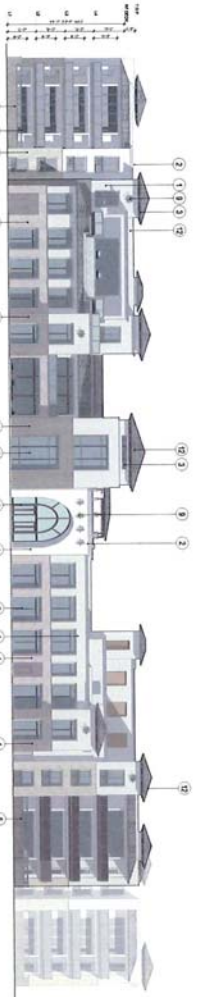


ELEVATION - "A" (COMMUNITY FACILITY)



ELEVATION - "B" (COMMUNITY FACILITY/BLDG 1)



ELEVATION - "C" (BLDG 1)

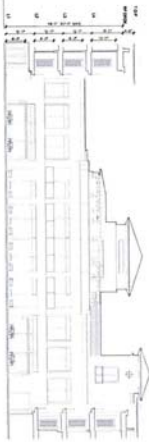


ELEVATION - "C" (COMMUNITY FACILITY)



ELEVATION - "D" (BLDG 1)

1	Building - Wall Building - Veranda Edge Building - Wall Niche	
2	Facade Foam - Residential Veranda Facade Foam - Community Facility Entry	
3	DBI Corbels with trim board behind Rafter Tail	
4	Stone - Building Wall Stone - Building Wall	
5	Stone - Garden Walls with stone cap Stone - Pore Corbels with stone cap	
6	Window / Door - Residential Units Window / Door - Community Facility	
7	Glazing - Door and Window	
8	Railing	
9	Pore Corbels Access Ornle	
10	Building Lighting	
11	Roof - Flat	
12	Roof - Flat Tile	

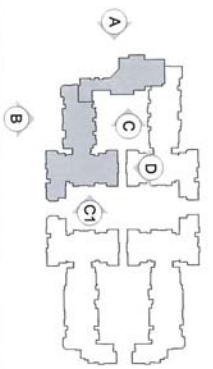

16-DR-2017
7/13/17

A-1.10

ARCHITECT
RUCILLA GROUP
ARCHITECTURE
1000 W. 10th Street, Suite 100
Denver, CO 80202
Tel: 303.733.1111
www.rucilla.com



Project
ARTISA
M. SCHROEDER, ARCHITECT
MID-RISE RESIDENTIAL
BUILDING (P-4)

Owner
ARTISA DEVELOPMENT
PARKS, LLC
3500 W. 10th Street

NO DATE DESCRIPTION

DATE	BY	DESCRIPTION

Project Number
BCA No. 1529 (P-4)

Project Name
BUILDING ELEVATIONS
COMMUNITY FACILITY

Scale
AS SHOWN



PA-1
 COMMUNITY FACILITY
 ILLUSTRATION - 3

ARCHITECT
B LUCILLA
C ROP
A RCHITECTURE
 10000 W. CENTRAL EXPRESSWAY, SUITE 100
 WEST VALLEY CITY, UT 84119
 TEL: 801.973.1100 FAX: 801.973.1101
 WWW.BLUCILLACROUP.COM



PROJECT
 ARTESIA
 7TH FLOOR, WESTON
 MID-RISE RESIDENTIAL
 COMMUNITY FACILITY
 (PA-1)

DESIGNER
 ARTESIA DEVELOPMENT
 PARTNERS, LLC
 10000 W. CENTRAL EXPRESSWAY, SUITE 100
 WEST VALLEY CITY, UT 84119

NO. DATE DESCRIPTION
 1 7/13/17 PA-1 COMMUNITY FACILITY ILLUSTRATION - 3


PROJECT NUMBER
 BCA No. 16029 (PA-1)

PROJECT NAME
 PA-1
 COMMUNITY FACILITY
 ILLUSTRATION - 3

DATE
 7/13/17

SCALE
 IMC-3

16-DR-2017
 7/13/17

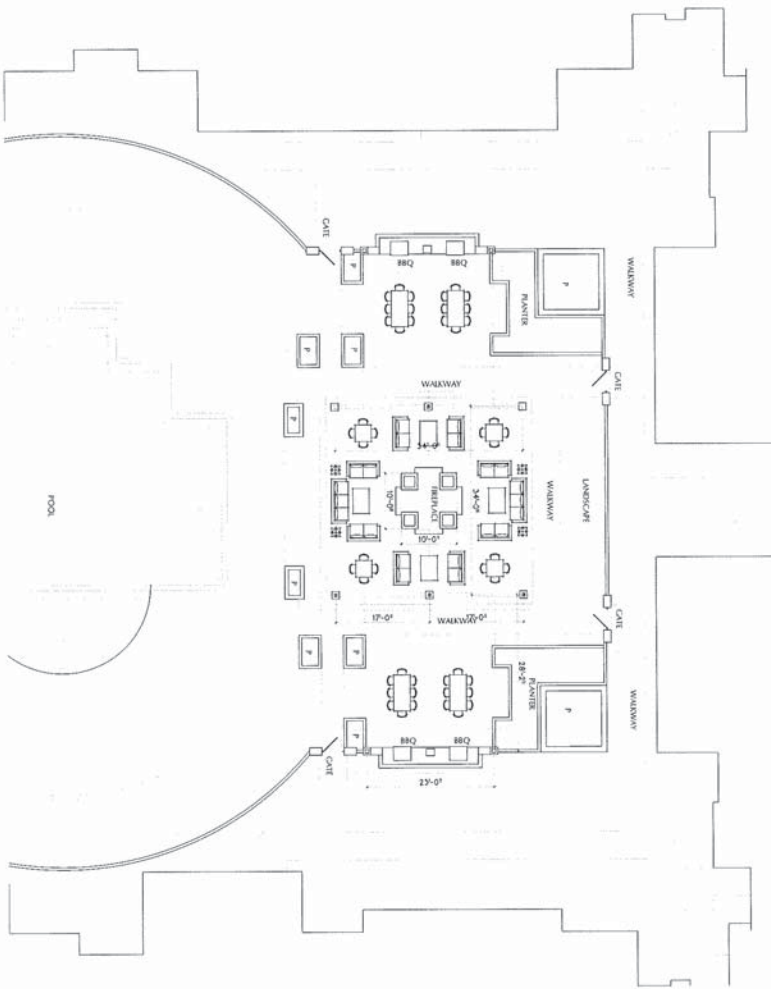

PA-1
SHADE STRUCTURE
TYPE - 3A PLAN



PROJECT ADDRESS:
 7171 N. SCOTTSDALE ROAD
 SCOTTSDALE, ARIZONA
 DBB SUBMITTAL 06-01-17

16-DR-2017
 7/13/17

ARCHITECT
BUCILLA
GROUP
 ARCHITECTURE
 American Institute of Architects
 1000 North Central Expressway
 Suite 1000, Scottsdale, Arizona 85260
 Tel: 480.344.1100 Fax: 480.344.1101
 www.bucillagroup.com



Project:
ARTSIA
 THE SHOPS
 SCOTTSDALE, ARIZONA

Owner:
ARTSIA DEVELOPMENT
 SCOTTSDALE, ARIZONA

NO DATE OCCUPATION
 (DATE) (PERMITS)


REVISION NO.	DATE	DESCRIPTION
1	7/13/17	ISSUE FOR PERMITS

BCA No. 15029

Project Title:
PA-1
SHADE STRUCTURE
TYP - 3A

Sheet No.
SS-3.0B

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LIGHT FIXTURE SCHEDULE

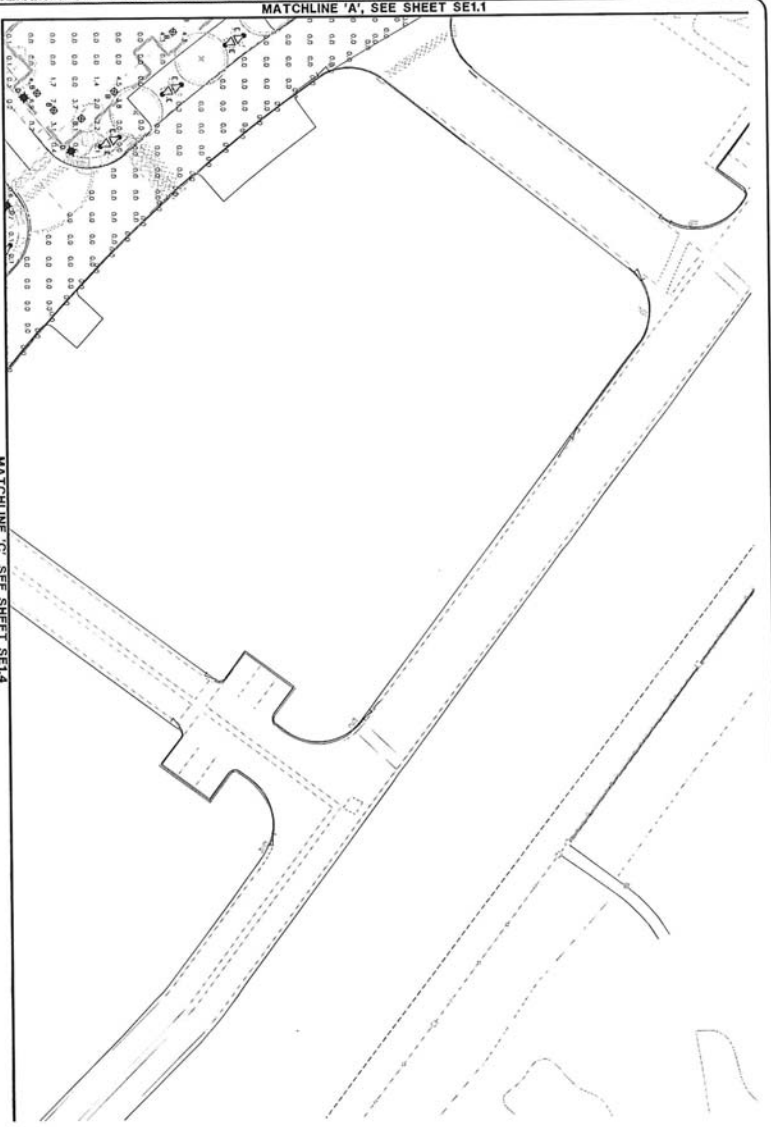KEY	SYMBOL	MANUFACTURER	CATALOG #	VOLTS	LAMP	CCT	LUMENS	FINISH
A		OSRAM	42080/2/120-2-N/AC1	120	32W LED	3000K	1047lm	WHITE
B		OSRAM	307W/2/120-2-N/AC1	120	15W LED	3000K	1154lm	WHITE
C		OSRAM	150W/2/120-2-N/AC1	120	7.5W LED	3000K	577lm	WHITE
D		OSRAM	75W/2/120-2-N/AC1	120	3.75W LED	3000K	288lm	WHITE
E		OSRAM	307W/2/120-2-N/AC1	120	15W LED	3000K	1154lm	WHITE
F		OSRAM	150W/2/120-2-N/AC1	120	7.5W LED	3000K	577lm	WHITE

PHOTOMETRIC LEGEND

1. **OVERHEAD AMBIENT LIGHTING (MOUNTING HEIGHT 12 FT)**
 1.00 = 1.00 foot-candle
 1.00 = 10.76 lux
 1.00 = 1.00 foot-candle
 1.00 = 10.76 lux

2. **307W AMBIENT LIGHTING (MOUNTING HEIGHT 12 FT)**
 1.00 = 1.00 foot-candle
 1.00 = 10.76 lux
 1.00 = 1.00 foot-candle
 1.00 = 10.76 lux

3. **150W AMBIENT LIGHTING (MOUNTING HEIGHT 12 FT)**
 1.00 = 1.00 foot-candle
 1.00 = 10.76 lux
 1.00 = 1.00 foot-candle
 1.00 = 10.76 lux

4. **75W AMBIENT LIGHTING (MOUNTING HEIGHT 12 FT)**
 1.00 = 1.00 foot-candle
 1.00 = 10.76 lux
 1.00 = 1.00 foot-candle
 1.00 = 10.76 lux

5. **307W AMBIENT LIGHTING (MOUNTING HEIGHT 12 FT)**
 1.00 = 1.00 foot-candle
 1.00 = 10.76 lux
 1.00 = 1.00 foot-candle
 1.00 = 10.76 lux

6. **150W AMBIENT LIGHTING (MOUNTING HEIGHT 12 FT)**
 1.00 = 1.00 foot-candle
 1.00 = 10.76 lux
 1.00 = 1.00 foot-candle
 1.00 = 10.76 lux

7. **75W AMBIENT LIGHTING (MOUNTING HEIGHT 12 FT)**
 1.00 = 1.00 foot-candle
 1.00 = 10.76 lux
 1.00 = 1.00 foot-candle
 1.00 = 10.76 lux

PHOTOMETRIC RESULTS

Point: 100
 Foot-candle: 1.00
 Lux: 10.76
 Foot-candle: 1.00
 Lux: 10.76

Point: 101
 Foot-candle: 1.00
 Lux: 10.76
 Foot-candle: 1.00
 Lux: 10.76

Point: 102
 Foot-candle: 1.00
 Lux: 10.76
 Foot-candle: 1.00
 Lux: 10.76

Point: 103
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 Lux: 10.76
 Foot-candle: 1.00
 Lux: 10.76

Point: 104
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 Lux: 10.76
 Foot-candle: 1.00
 Lux: 10.76

Point: 105
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 Lux: 10.76
 Foot-candle: 1.00
 Lux: 10.76

Point: 106
 Foot-candle: 1.00
 Lux: 10.76
 Foot-candle: 1.00
 Lux: 10.76

Point: 107
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 Lux: 10.76
 Foot-candle: 1.00
 Lux: 10.76

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 Lux: 10.76
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 Lux: 10.76

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 Lux: 10.76

Point: 111
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 Lux: 10.76
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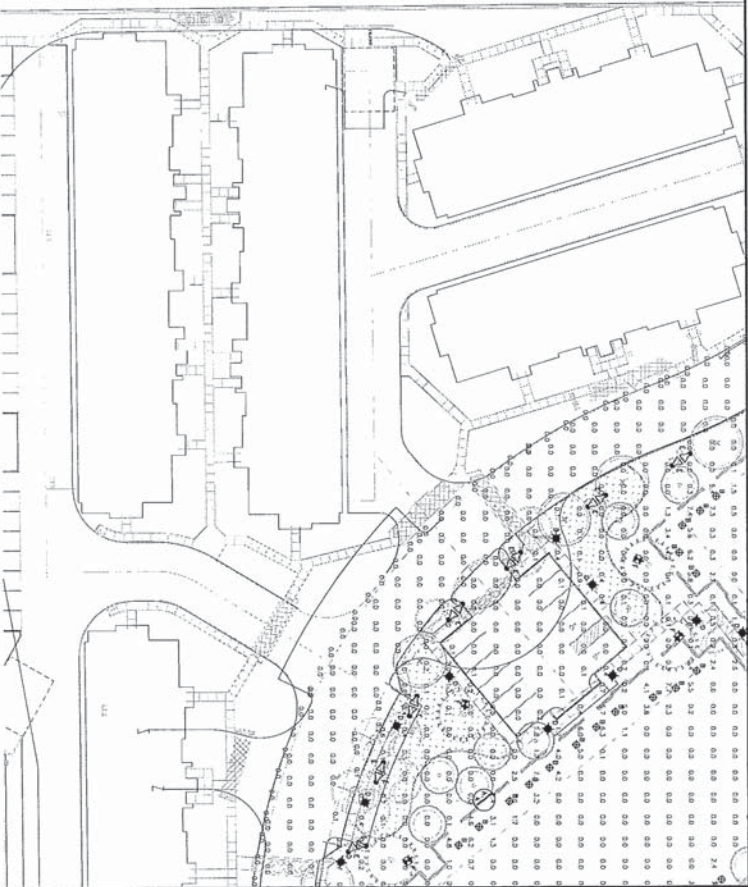
SCOTTSDALE, ARIZONA
ARTESIA
SCOTTSDALE RD AND INDIAN BEND
PHOTOMETRIC ANALYSIS

WRIGHT
 engineering corporation
 185 EAST CHILTON BLVD • CHANDLER, ARIZONA 85225
 PHONE: 480.940.1424 • FAX: 480.940.8837
 www.wrighteng.com

PROJECT NO: 17008
 SCALE: AS SHOWN
 DATE: 7/13/17
 CHECKED BY: CAC

SHEET NO: SET 2 OF 3

16-DR-2017
 7/13/17



MATCHLINE 'E', SEE SHEET SET.3

MATCHLINE 'G', SEE SHEET SET.6

LIGHT FIXTURE SCHEDULE

KEY	SYMBOL	MANUFACTURER	MODEL #	VOLTS	LAMP	CCT	LUMENS	FINISH
A	T	OSRAM	430007471120-2-2V40T	120	34W LED	2700K	1660LM	SLA
B	Q	OSRAM	43-1120271-H	120	19W LED	3000K	1,150	WHITE
C	F	OSRAM	15001401212V40T/2P	120	34W LED	3000K	232	BRONZE
D	M	OSRAM	90317442V40T	120	19W LED	3000K	335	BRONZE
E	C	OSRAM	11501401212V40T/2P-377AL/2C	120	34W LED	3000K	171	BRONZE
F	H	OSRAM	15001401212V40T/2P	120	34W LED	3000K	487	BRONZE

PHOTOMETRIC LEGEND

- 1. SECTION: ARTISIA LIGHTING MATCHLINE
- 2. SECTION: ARTISIA LIGHTING MATCHLINE
- 3. SECTION: ARTISIA LIGHTING MATCHLINE
- 4. SECTION: ARTISIA LIGHTING MATCHLINE
- 5. SECTION: ARTISIA LIGHTING MATCHLINE
- 6. SECTION: ARTISIA LIGHTING MATCHLINE
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- 8. SECTION: ARTISIA LIGHTING MATCHLINE
- 9. SECTION: ARTISIA LIGHTING MATCHLINE
- 10. SECTION: ARTISIA LIGHTING MATCHLINE
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- 12. SECTION: ARTISIA LIGHTING MATCHLINE
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- 14. SECTION: ARTISIA LIGHTING MATCHLINE
- 15. SECTION: ARTISIA LIGHTING MATCHLINE
- 16. SECTION: ARTISIA LIGHTING MATCHLINE
- 17. SECTION: ARTISIA LIGHTING MATCHLINE
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- 19. SECTION: ARTISIA LIGHTING MATCHLINE
- 20. SECTION: ARTISIA LIGHTING MATCHLINE
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- 99. SECTION: ARTISIA LIGHTING MATCHLINE
- 100. SECTION: ARTISIA LIGHTING MATCHLINE

SCOTTSDALE, ARIZONA
ARTISIA
SCOTTSDALE RD AND INDIAN BEND
PHOTOMETRIC ANALYSIS



PROJECT NO. 17006
DATE: 7/13/17
DRAWN BY: [Name]
CHECKED BY: [Name]




16-DR-2017
7/13/17

NO.	DATE	DESCRIPTION
1	7/13/17	PHOTOMETRIC ANALYSIS
2	7/13/17	PHOTOMETRIC ANALYSIS
3	7/13/17	PHOTOMETRIC ANALYSIS

WRIGHT ENGINEERING CORPORATION
LED LIGHTING
 Slope Function, Vandal-Resistant, Aluminum Shell
 Model 1181 • 18" x 18" x 3"

Year: _____
 Make: _____
 Price: _____

Specifications
 Model 1181 is a square, vandal-resistant, aluminum shell, LED lighting fixture. It is designed for use in high-traffic areas and is suitable for both indoor and outdoor applications. The fixture is made of die-cast aluminum and is finished with a powder-coat paint. It is available in two finishes: silver and black. The fixture is designed to be mounted on a wall or ceiling and is suitable for use in areas where vandalism is a concern. The fixture is designed to be easy to install and maintain. It is suitable for use in areas where a high level of security is required. The fixture is designed to be suitable for use in areas where a high level of security is required. The fixture is designed to be suitable for use in areas where a high level of security is required.

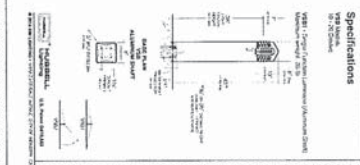

Labels
 18" x 18" x 3"
 18" x 18" x 3"
 18" x 18" x 3"


Notes
 1. See drawing for dimensions and details.
 2. See drawing for mounting details.
 3. See drawing for finish details.

Notes
 1. See drawing for dimensions and details.
 2. See drawing for mounting details.
 3. See drawing for finish details.

WRIGHT ENGINEERING CORPORATION
LED LIGHTING
 Slope Function, Vandal-Resistant, Aluminum Shell
 Model 1182 • 18" x 18" x 3"

Year: _____
 Make: _____
 Price: _____

Specifications
 Model 1182 is a square, vandal-resistant, aluminum shell, LED lighting fixture. It is designed for use in high-traffic areas and is suitable for both indoor and outdoor applications. The fixture is made of die-cast aluminum and is finished with a powder-coat paint. It is available in two finishes: silver and black. The fixture is designed to be mounted on a wall or ceiling and is suitable for use in areas where vandalism is a concern. The fixture is designed to be easy to install and maintain. It is suitable for use in areas where a high level of security is required. The fixture is designed to be suitable for use in areas where a high level of security is required.

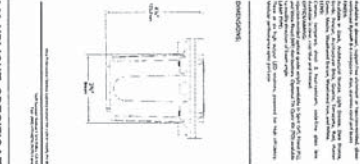


Labels
 18" x 18" x 3"
 18" x 18" x 3"
 18" x 18" x 3"

Notes
 1. See drawing for dimensions and details.
 2. See drawing for mounting details.
 3. See drawing for finish details.

WRIGHT ENGINEERING CORPORATION
LED LIGHTING
 Slope Function, Vandal-Resistant, Aluminum Shell
 Model 1183 • 18" x 18" x 3"

Year: _____
 Make: _____
 Price: _____

Specifications
 Model 1183 is a square, vandal-resistant, aluminum shell, LED lighting fixture. It is designed for use in high-traffic areas and is suitable for both indoor and outdoor applications. The fixture is made of die-cast aluminum and is finished with a powder-coat paint. It is available in two finishes: silver and black. The fixture is designed to be mounted on a wall or ceiling and is suitable for use in areas where vandalism is a concern. The fixture is designed to be easy to install and maintain. It is suitable for use in areas where a high level of security is required. The fixture is designed to be suitable for use in areas where a high level of security is required.

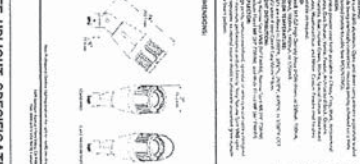

Labels
 18" x 18" x 3"
 18" x 18" x 3"
 18" x 18" x 3"

Notes
 1. See drawing for dimensions and details.
 2. See drawing for mounting details.
 3. See drawing for finish details.

WRIGHT ENGINEERING CORPORATION
LED LIGHTING
 Slope Function, Vandal-Resistant, Aluminum Shell
 Model 1184 • 18" x 18" x 3"

Year: _____
 Make: _____
 Price: _____

Specifications
 Model 1184 is a square, vandal-resistant, aluminum shell, LED lighting fixture. It is designed for use in high-traffic areas and is suitable for both indoor and outdoor applications. The fixture is made of die-cast aluminum and is finished with a powder-coat paint. It is available in two finishes: silver and black. The fixture is designed to be mounted on a wall or ceiling and is suitable for use in areas where vandalism is a concern. The fixture is designed to be easy to install and maintain. It is suitable for use in areas where a high level of security is required. The fixture is designed to be suitable for use in areas where a high level of security is required.

Labels
 18" x 18" x 3"
 18" x 18" x 3"
 18" x 18" x 3"

Notes
 1. See drawing for dimensions and details.
 2. See drawing for mounting details.
 3. See drawing for finish details.

WRIGHT ENGINEERING CORPORATION
 16-DR-2017
 7/13/17


SCOTTSDALE, ARIZONA
ARTESIA
SCOTTSDALE RD AND INDIAN BEND
LIGHTING SPECIFICATIONS

WRIGHT
 engineering corporation
 ELECTRICAL ENGINEERING AND DESIGN
 105 EAST CHANDLER BOULEVARD • CHANDLER, ARIZONA 85226
 PHOENIX 480.947.5327 • FAX 480.947.5337
 WWW.WRIGHT-ENG.COM

PROJECT NO. 17006
 SCALE: AS SHOWN
 CHECKED BY: CUP
 DATE: 7/13/17

DATE: 7/13/17
 TIME: 10:00 AM
 BY: CUP
 CHECKED BY: CUP
 DATE: 7/13/17

SE22
 OF 8

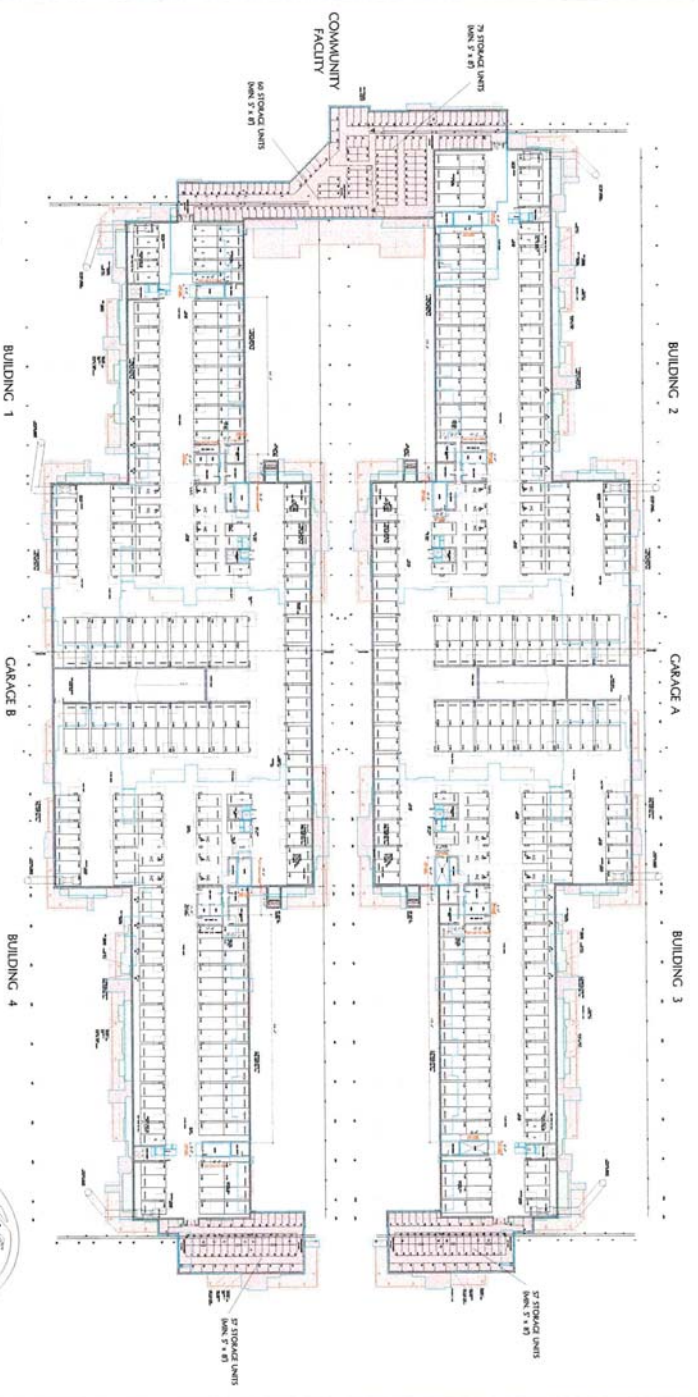

LEGEND:

-  EXISTING PROGRAM STRUCTURAL / VERANDA OPENING
-  NEW STRUCTURAL OPENING
-  NEW EXTENDED VERANDA OVERPOUR
-  NEW BUILDING LINE AT FIRST FLOOR LEVEL
-  NEW VERANDA LINES
-  EXISTING WALL/DOOR TO BE BUILT
-  NEW 2" BLOCK WALL
-  NEW 3" CONCRETE WALL



**COMBINED GARAGE PLAN
GARAGE A, B, & COMM. FACILITY**
SCALE 1/32" = 1'


GARAGE & STORAGE - AREA CALC.

MANAGEMENT NO.	AREA (SQ)
GARAGE A	8750
GARAGE B	4347
STORAGE (A)	1034
STORAGE (B)	2646
TOTAL	16777

NOTE: DIMENSIONS TO CENTERLINE UNLESS NOTED OTHERWISE.



KEYPLAN

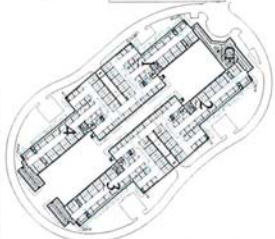

PROJECT ADDRESS:
1711 N. SCOTTSDALE ROAD
SCOTTSDALE, ARIZONA
098 SUBMITTAL - 16-DR-2017

16-DR-2017
7/13/17

ARCHITECT: **BUCILLA GROUP ARCHITECTURE**
 1600 N. CENTRAL AVENUE, SUITE 1000
 PHOENIX, ARIZONA 85004
 TEL: 602.955.1100
 FAX: 602.955.1101
 WWW.BUCILLAGROUP.COM

PROJECT: **ARTESIA DEVELOPMENT**
 1711 N. SCOTTSDALE ROAD
 SCOTTSDALE, ARIZONA


DATE: 08/20/17
 DRAWING NO.: 16-DR-2017-01

PROJECT NUMBER: **BCA No. 15029**

DRAWING TITLE: **COMBINED GARAGE PLAN**

SCALE: **A-0.1**

STAMP: 

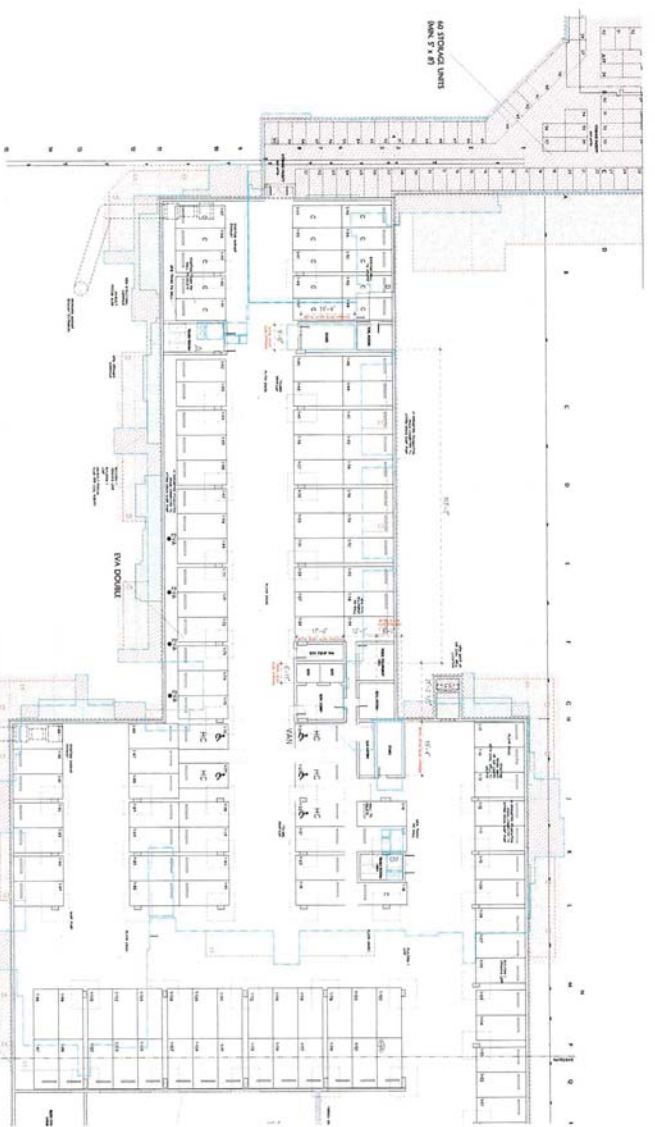

- LEGEND:**
- EXISTING ROOM STRUCTURAL / WALKWAY OVERPOUR
 - NEW STRUCTURAL OVERPOUR
 - NEW EXTENDED WALKWAY OVERPOUR
 - NEW BUILDING LINE AT FIRST FLOOR LEVEL
 - NEW WALKWAY LINES
 - EXISTING WALKWOODS (TO DELETED)
 - NEW 12" BLOCK WALL
 - NEW 12" CONCRETE WALL
- PARKING:**
- 1. STALLS 123 SPACES
 - 2. HANDICAP 5 SPACES W/ VAN
 - 3. EVA 8 SPACES
 - 4. BIKES 1 PER STO. UNIT
- 0' 10' 20'
- SCALE: 1/8" = 1'-0"

**COMMUNITY FACILITY
BLDG 1 / PLAZA
GARAGE B
PARTIAL PLAN**

SCALE 1/8" = 1'

GARAGE B STRIP/SLICE - AREA CALC'S

Garage/Striping No.	Area Calc's
GARAGE A	8715
GARAGE B	4347
STRIPING (A)	584
STRIPING (B)	584
STRIPING (C)	584
STRIPING (D)	584
STRIPING (E)	584
STRIPING (F)	584
STRIPING (G)	584
STRIPING (H)	584
STRIPING (I)	584
STRIPING (J)	584
STRIPING (K)	584
STRIPING (L)	584
STRIPING (M)	584
STRIPING (N)	584
STRIPING (O)	584
STRIPING (P)	584
STRIPING (Q)	584
STRIPING (R)	584
STRIPING (S)	584
STRIPING (T)	584
STRIPING (U)	584
STRIPING (V)	584
STRIPING (W)	584
STRIPING (X)	584
STRIPING (Y)	584
STRIPING (Z)	584



PROJECT ADDRESS:
1711 N. SCOTTSDALE ROAD
SCOTTSDALE, ARIZONA

PROJECT NUMBER:
A-0-1A

PROJECT NAME:
COMMUNITY FACILITY
BLDG 1 / PLAZA
GARAGE B

BCA No. 15029

DATE:
7/13/17

**16-DR-2017
7/13/17**

ARCHITECT:

**BUCILLA
GROUP
ARCHITECTURE**

1711 N. SCOTTSDALE ROAD
SCOTTSDALE, ARIZONA 85251
TEL: 480.344.1111 FAX: 480.344.1112


PROJECT:

**ARTESIA
COMMUNITY FACILITY
SCOTTSDALE, ARIZONA**

DATE: 7/13/17

SCALE: 1/8" = 1'-0"

STAMP

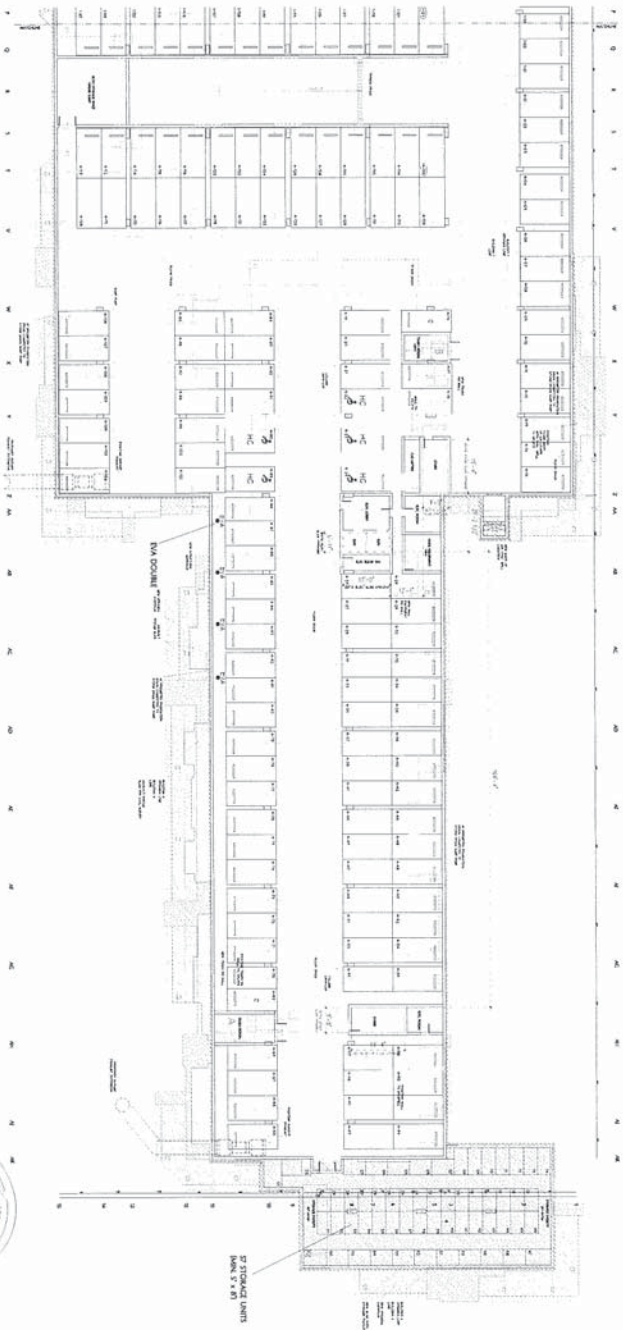

LEGEND:

- EXISTING POST-TENSION STRUCTURAL / VOIDWORK
- NEW STRUCTURAL OVERHEAD
- NEW STRUCTURAL OVERHEAD
- NEW STRUCTURAL OVERHEAD
- NEW BUILDING LINE AT FIRST FLOOR LEVEL
- NEW VOIDWORK LINE
- EXISTING WALLSTOPPERS TO BE LEFT
- NEW 12" RIGID WALL
- NEW 12" CONCRETE WALL

PARKING:

- 1. STALLS
- 2. HANDICAP
- 3. EVA
- 4. BIKES
- 5. 723 SPACES
- 6. 5 SPACES W/ VAN
- 7. 8 SPACES
- 8. 1 PER STO. UNIT

SCALE: 1/16" = 1'-0"

(PLAZA / BLDG 4)
 GARAGE B
 PARTIAL PLAN
 SCALE 7/16" = 1'

GRABER & SCHWABE - ARTSIA CALCS

GRABER/STANDARD NO.	ARTSIA (P)
GRABER A	5/15/16
GRABER B	6/15/17
STANDARD (R)	2/16/18
STANDARD (L)	2/16/18

THIS DRAWING AND EXISTENCE INFORMATION HAS BEEN CHECKED BY GRABER & SCHWABE ARCHITECTS, P.C.



16-DR-2017
 7/13/17

ARCHITECT:
BUCILLA
G RUPP
ARCHITECTURE
 1000 N. CENTRAL AVENUE, SUITE 200
 PHOENIX, ARIZONA 85004
 TEL: 602.254.1100
 FAX: 602.254.1101
 WWW.BUCILLAGROUP.COM




Project:
 ARTSIA
 771 N. SCOTTSDALE ROAD
 SCOTTSDALE, ARIZONA

Owner:
 ARTSIA DEVELOPMENT
 771 N. SCOTTSDALE ROAD
 SCOTTSDALE, ARIZONA

NO.	DATE	DESCRIPTION
1	07/13/17	DRS SUBMITTAL


Project Number: BCA NO. 15029
Drawn Title: PLAZA, BLDG 4 GARAGE B
Drawn by: A-01B

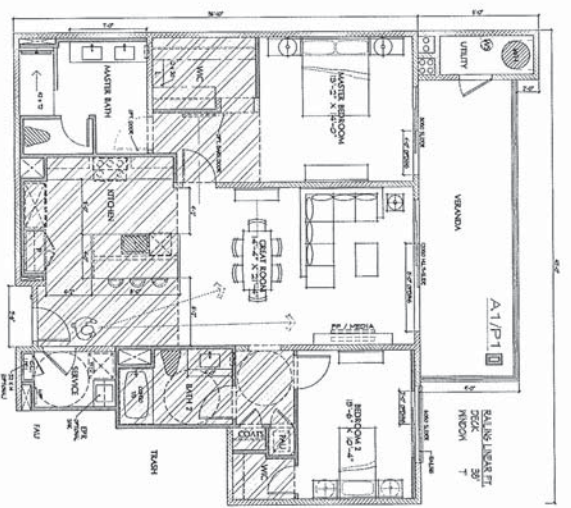

PLAN A1/P1

A1/P1	1,195	SF
VERANDA	1,245	SF
UTILITY	150	SF

UNIT PLANS

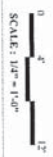

PROJECT ADDRESS:
 7171 N. SCOTTSDALE ROAD
 SCOTTSDALE, ARIZONA
 DRG SUBMITTAL 06-25-17

16-DR-2017
 7/13/17

Sheet No: **A-5.1**

Project No: **BCA NO. 15029**

Unit Plans
 - PLAN A1/P1


NO	DATE	DESCRIPTION

Prepared by:
ARTESIA
 2010 N. SCOTTSDALE
 SCOTTSDALE, ARIZONA

Checked by:
ARTESIA INTERIOR GROUP
 2010 N. SCOTTSDALE
 SCOTTSDALE, ARIZONA



ARCHITECT:
BUCILLA GROUP ARCHITECTURE
 1675 West Camelback Road, Suite 100
 Phoenix, Arizona 85015
 Phone: 602.998.1111
 Fax: 602.998.1112
 Email: info@bucillagroup.com
 Website: www.bucillagroup.com

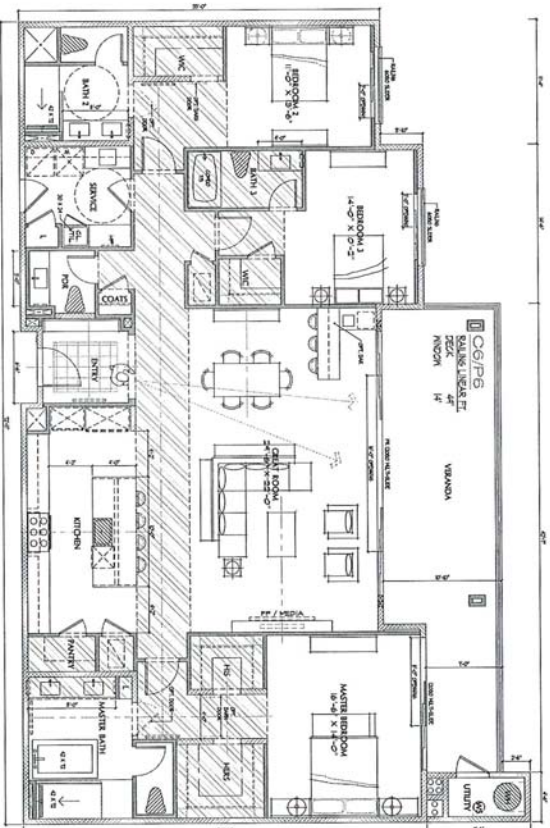

PLAN C6 / P6

C6/P6	SF
LIVING	2500
VERANDA	410
TOTAL	2910

UNIT PLANS



PROJECT ADDRESS:
 7171 N. SCOTTSDALE ROAD
 SCOTTSDALE, ARIZONA
 DBB SUBMITTAL 06-26-17

16-DR-2017
 7/13/17

Sheet No.:
A-57

Project Number:
 BCA No. 15029

Sheet Title:
 UNIT PLANS
 - PLAN C6 / P6




NO.	DATE	DESCRIPTION

Architect:
ARTESIA GROUP ARCHITECTURE
 ARTESIA GROUP ARCHITECTURE
 2700 N. SCOTTSDALE AVENUE
 SCOTTSDALE, ARIZONA

Project:
 7171 N. SCOTTSDALE AVENUE
ARTESIA GROUP ARCHITECTURE
 2700 N. SCOTTSDALE AVENUE
 SCOTTSDALE, ARIZONA



Architect:
BUCILLA GROUP ARCHITECTURE
 BUCILLA GROUP ARCHITECTURE
 10000 N. CENTRAL AVENUE, SUITE 100
 SCOTTSDALE, ARIZONA 85258
 TEL: 480.343.8888 FAX: 480.343.8889
 WWW.BUCILLAGROUP.COM

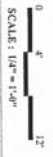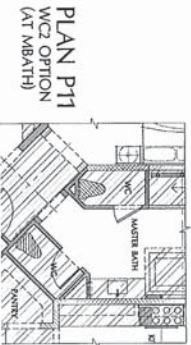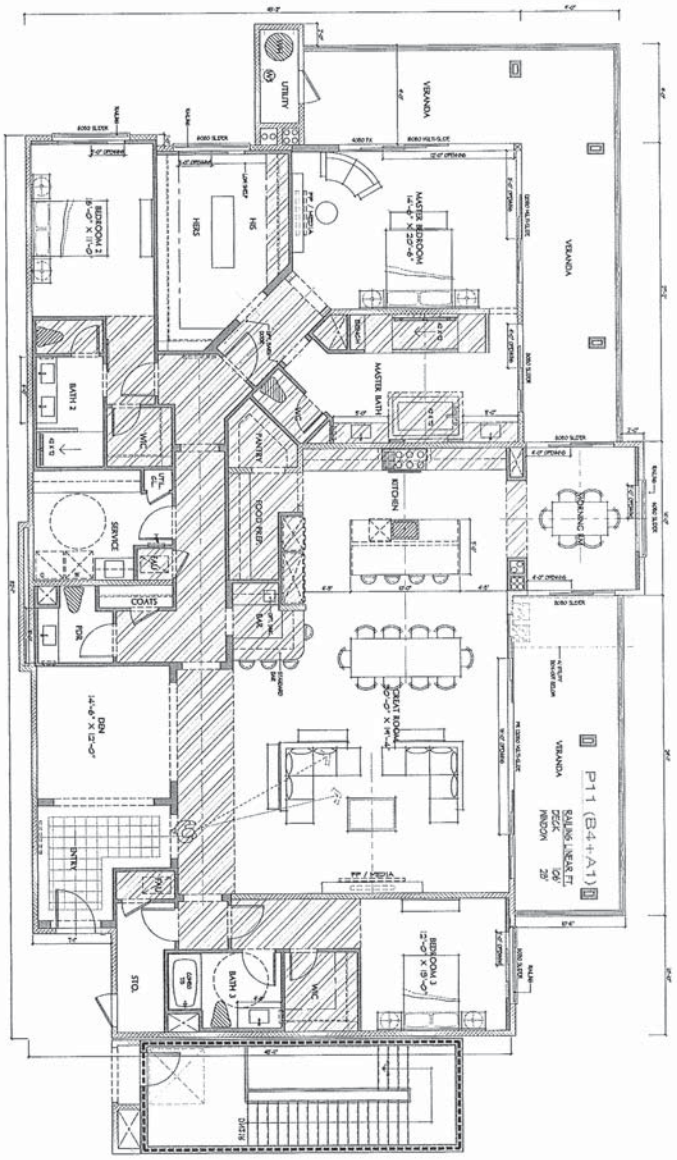

PROJECT ADDRESS:
7171 N. SCOTTSDALE ROAD
SCOTTSDALE, ARIZONA
DNR SB/BU/VAL 06-29-17

Project Number: BCA No. 15029
 Sheet Title: UNIT PLANS - PLAN 11
 Drawn By: A-5.14

16-DR-2017
7/13/17

NO.	DATE	DESCRIPTION

OWNER:
ARTESIA DEVELOPMENT
7171 N. SCOTTSDALE ROAD
SCOTTSDALE, ARIZONA

DESIGNED BY:
BUCILLA GROUP ARCHITECTURE

DATE: 06/29/17

PROJECT: 16-DR-2017


SCALE: 1/8" = 1'-0"

STAMP: [Professional Engineer Seal]

EXPIRES: 06/29/2021

ARCHITECT:
BUCILLA
GROUP
ARCHITECTURE

15000 N. CENTRAL EXPRESSWAY, SUITE 100
SCOTTSDALE, ARIZONA 85254
PH: 480.344.1100 FAX: 480.344.1101
WWW.BUCILLAGROUP.COM

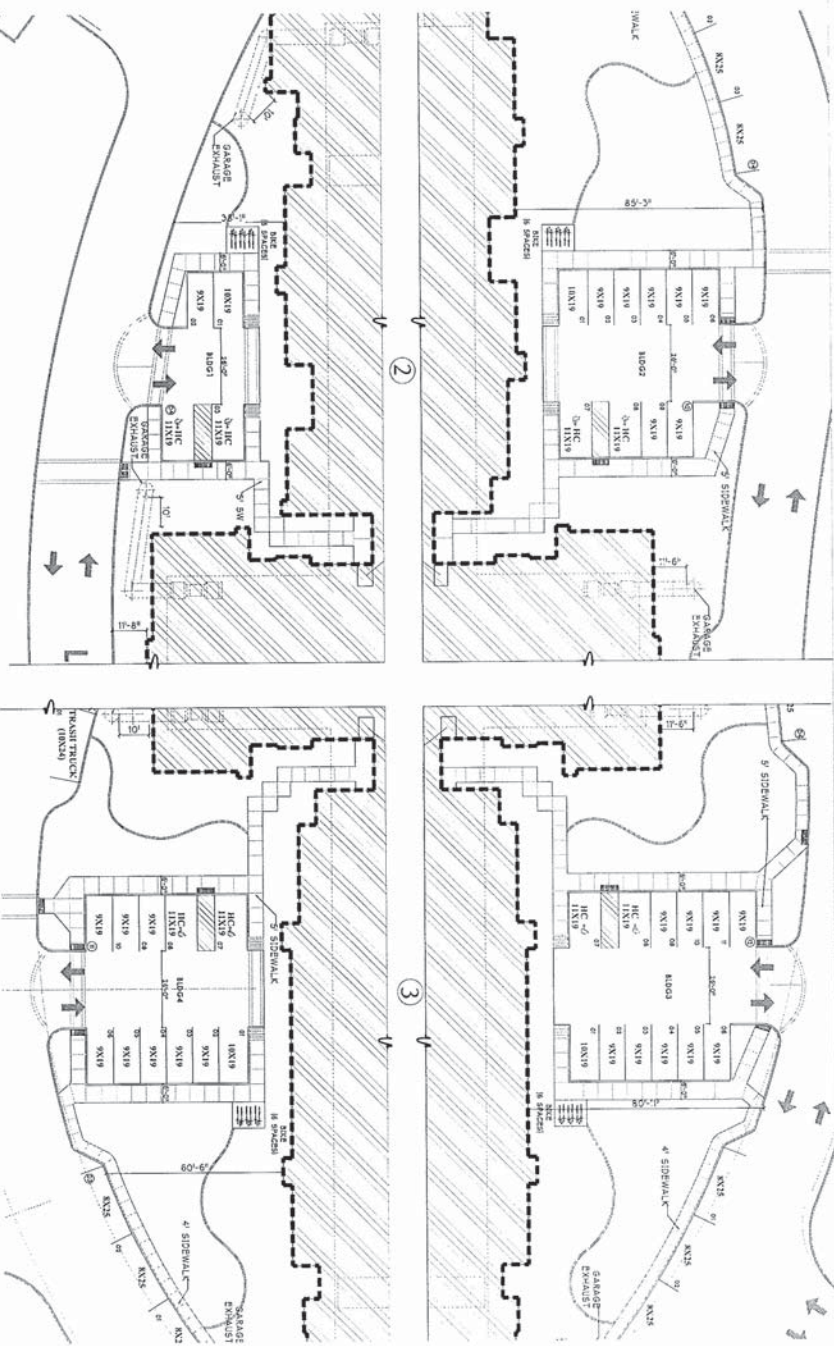

GUEST PARKING PLAN
PA-1
SITE DEVELOPMENT PLAN
 SCALE 1" = 15'

PROJECT ADDRESS:
 7171 N. SCOTTSDALE ROAD
 SCOTTSDALE, ARIZONA
OWNER: SCOTTSDALE 602-952-9777

16-DR-2017
 7/13/17

<p>ARCHITECT:</p> <p>BUCILLA ROUP ARCHITECTURE</p> <p><small>10101 North 16th Avenue, Suite 100 Scottsdale, Arizona 85258 Phone: 480-344-8888 Fax: 480-344-8889 www.bucillaroup.com</small></p>	<p>PROJECT:</p> <p>ARTSIA HOME SCOTTSDALE, ARIZONA</p>	<p>DATE:</p> <p>ARTSIA DEVELOPMENT FAMILY LLC SCOTTSDALE, ARIZONA</p>	<p>DATE:</p> <p>16-DR-2017</p>	<p>PROJECT NUMBER:</p> <p>BCA No. 15029</p>	<p>SHEET TITLE:</p> <p>PA-1 GUEST PARKING PLAN</p>	<p>SHEET NO.:</p> <p>SP-1.0A</p>
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